



## JOHNSON COUNTY, IOWA

**APPLICATION FOR: SITE PLAN REVIEW** 



In accordance with chapter 8:1.25 of the Johnson County Unified Development Ordinance, a site plan shall be reviewed prior to issuance of a building permit in the RR, C, CH, AG-T, C-AG, ML, MH, and SWDRR zoning districts, and prior to commencing certain conditional uses permitted by the Board of Adjustment where required by Chapter 8:1.23.

Proposed Use of Structure(s): Auto Truck Center & RV sales center		
Address of Location: 1152 h	IWY 965 NW	
Subdivision Name and Lo	t Number: Lot 1, Swisher 60 Subdivision *proceeding through the approval process not yet recorded	
Current Zoning: ML	Parcel Number: 0304326002, 0304301002, 0304351004, 0304376002	
	applications are not subject to the standard filing deadlines for development ubmitted at any time. Once complete, they will be placed on the next available Board enda.	
affirms that the owner(s) of said owners hereby give th	PLEASE PRINT OR TYPE It the information provided herein is true and correct. If applicant is not the owner, applicant the property described on this application consent to this application being submitted, and eir consent for the office of Johnson County Planning, Development, and Sustainability to ograph the subject property.	
2612 REC, LLC c/o Todd Philipp		
Name of Owner	Name of Applicant (if different)	
941 66th Ave SW, Cedar Rapids, IA 5	2404	
Applicant Street Address (	including City, State, Zip)	
319-533-5009	toddphilipp@autotruckcenter.net	
Applicant Phone	Applicant Email	
Applicant Signature	6	

See back page for Application Submittal Requirements and Checklist

The following items must be submitted for the application to be complete. Once submitted county staff will review the materials and request revisions (if necessary). Once all revisions and outside reviews have been received, the application will be placed on the next available Board of Supervisors agenda.

Electronic submissions — including CAD or GIS line work — should be submitted in accordance with the PLANIGED artment electronic submission guidelines (see below). Preference is that electronic submission is provided submission.

<u>Initial each item below</u> to confirm that you are aware of the submittal requirements for an application to be considered complete.

LSS	A letter of intent explaining the proposed use including but not limited to the type of business, number of employees, parking facilities proposed, days and hours of operation, provisions for water and wastewater, type of equipment to be used, and signage.
LSS	Two (2) copies of the site plan which includes all information required by section 8:1.25 of the Johnson County Unified Development Ordinance, including:
	LSS Landscape Plan – should be a dedicated sheet
	LSS Grading Plan, including Erosion and Sediment Control Plan/SWPPP – should be a dedicated sheet.
	Paving detail for entrances, drives, parking areas – can be included on other sheets or be on a dedicated sheet.
	Sensitive Areas Exhibit (delineations from the Sensitive Areas Report, shown on a dedicated sheet at the same scale as the site plan. This exhibit should show all proposed disturbance on the site including proposed building footprints and the extent of any grading).
LSS	A copy of an approved ROW Permit (Access Permit) from Johnson County Secondary Roads or Iowa DOT for access sufficient to serve the use proposed in the application.
LSS	Application Fee (\$250) is due at the time of submittal.
LSS	One (1) copy of the Sensitive Areas Analysis in compliance with the Sensitive Areas Ordinance.
LSS	One (1) copy of the Stormwater Management Plan (including soil erosion and sediment control) in compliance with the Stormwater Management regulations, or an <u>approved</u> waiver.

<u>Electronic Submission Requirements</u> — an electronic submission of all hard-copy materials required above should be submitted prior to hard copy delivery. In all cases, electronic submission is due by 12 noon the day after the submittal deadline for the application to be considered complete. Electronic submissions should include, and conform with, the following:

Electronic or digitized copy (CAD line work or GIS geodatabase) of proposed plat in .dwg format (.dxf is also acceptable if .dwg is not an option. No .zip files will be accepted).

Submission must be saved in AutoCAD 2007 or older format.

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- Submissions must use Coordinate System: NAD 1983 StatePlane Iowa South FIPS 1402 Feet
- If applicable, submission <u>should include</u> existing structures (if any), property lines, road right-of-way lines, required setback lines, and requested setback lines.
- Submission <u>MUST</u> include information for Sensitive Areas Analysis/Mapping and Stormwater/Soil Erosion Control infrastructure on the site. This includes any limits of disturbance or other impact areas.
- Submission should **NOT** include legends, legal descriptions, location maps, signature blocks, etc.

A PDF of the entire application packet. A single PDF preferred; but a separate PDF for site plan, application materials, sensitive areas documentation, stormwater plan, and legal documents (if applicable) is acceptable.

MMS Consultants, Inc.

Experts in Planning and Development Since 1975

1917 S. Gilbert Street Iowa City, Iowa 52240

319.351.8282

mmsconsultants.net mms@mmsconsultants.net

May 21st, 2024

Mr. Josh Busard Johnson County Planning, Development, & Sustainability Dept. 913 S. Dubuque St, Suite 204 Iowa City, IA 52240

RE: Lot 1, Swisher 60 Subdivision

Dear Josh:

On behalf of 2612 REC, LLC c/o Todd Philipp, we are submitting a site plan for Lot 1 of Swisher 60 Subdivision (subdivision pending final approval and recording). Lot 1 is currently zoned Light Industrial (ML) and is 17.26 acres in size. The site plan proposes the construction of a 53,000 SF auto truck center which will serve both as a dealership and a repair center, with the latter being the more dominant use. The site plan also illustrates an accessory building in the northeast corner of the site, a 2,112 SF shed that will be relocated to this area that was existing on a different portion of the Swisher 60 Subdivision.

Main access to Lot 1 will be facilitated by installation of a permanent dust free surface driveway to HWY 965 NW via a 66' wide ingress, egress and utility easement being established with the Swisher 60 Subdivision final plat. A ROW permit has been received by the City of Cedar Rapids for this access and included in this submittal package. The lot will also be accessible via Anderson Ave NW as shown on the site plan, also facilitated by a 66' wide ingress, egress, and utility easement.

The new facility will be served by a new well that will be located along the western line of Lot 1, featuring two (2) 10,000 gallon non-potable water storage tanks. The new facility will also be served by a new septic system to the south of the building, design of which has been included in the site plan. A wet bottom basin has been designed to facilitate stormwater management of Lot 1, as well as a majority of Swisher 60 Subdivision for the future development. A sensitive areas report was approved prior to subdividing, and updated and approved with the Swisher 60 Subdivision preliminary plat.

We have utilized the overstory and understory reductions to landscaping as outlined in section 8:1.25.6.b.v. of the PDS working copy of the county ordinances which incorporate the approved amendments.

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Please feel free to reach out with any questions or concerns.

Respectfully submitted,

Lacey Stutzman

11801-001L4.docx

1917 S. Gilbert Street lowa City, lowa 52240 **319.351.8282** 

mmsconsultants.net mms@mmsconsultants.net

## LETTER OF TRANSMITTAL

	Johnson County Planning,	
TO:	Development, & Sustainability Dept.	

Date: 5/23/202 Project #: 11801-001

From: Lacey Stutzman

RE: Lot 1 Swisher 60 Subdivision - Site Plan

We are sending you the following attached items:

COPIES	DATE	PROJECT NO.	DESCRIPTION	
2			Site plan	
1			Letter of Intent	
1			Signed Application	
1			Check for filing fee \$250, MMS check #71904	
			850	
10				
		•		

□ For approval     □ For your use     □ As requested     □ For review & comment	Approved as submitted Approved as noted Returned as noted Prints returned after loan to us	☐ For Approval & Signature ☐ Submit copies for distribution ☐ For Recording ☐ Other
REMARKS:		
MMS Consultants, Inc.		
COPY TO:		
Received by:	Date:	Time:
IF ENCLOSE	URES ARE NOT NOTED, KINDLY NO	OTIFY US AT ONCE.

LAND PLANNERS

LAND SURVEYORS

1917 S. GILBERT ST.


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LANDSCAPE ARCHITECTS

**ENVIRONMENTAL SPECIALISTS** 




# SITE PLAN LOT 1, SWISHER 60 SUBDIVISION JOHNSON COUNTY, IOWA

PLAN PREPARED BY: MMS CONSULTANTS INC. 1917 S. GILBERT STREET IOWA CITY, IOWA 52240

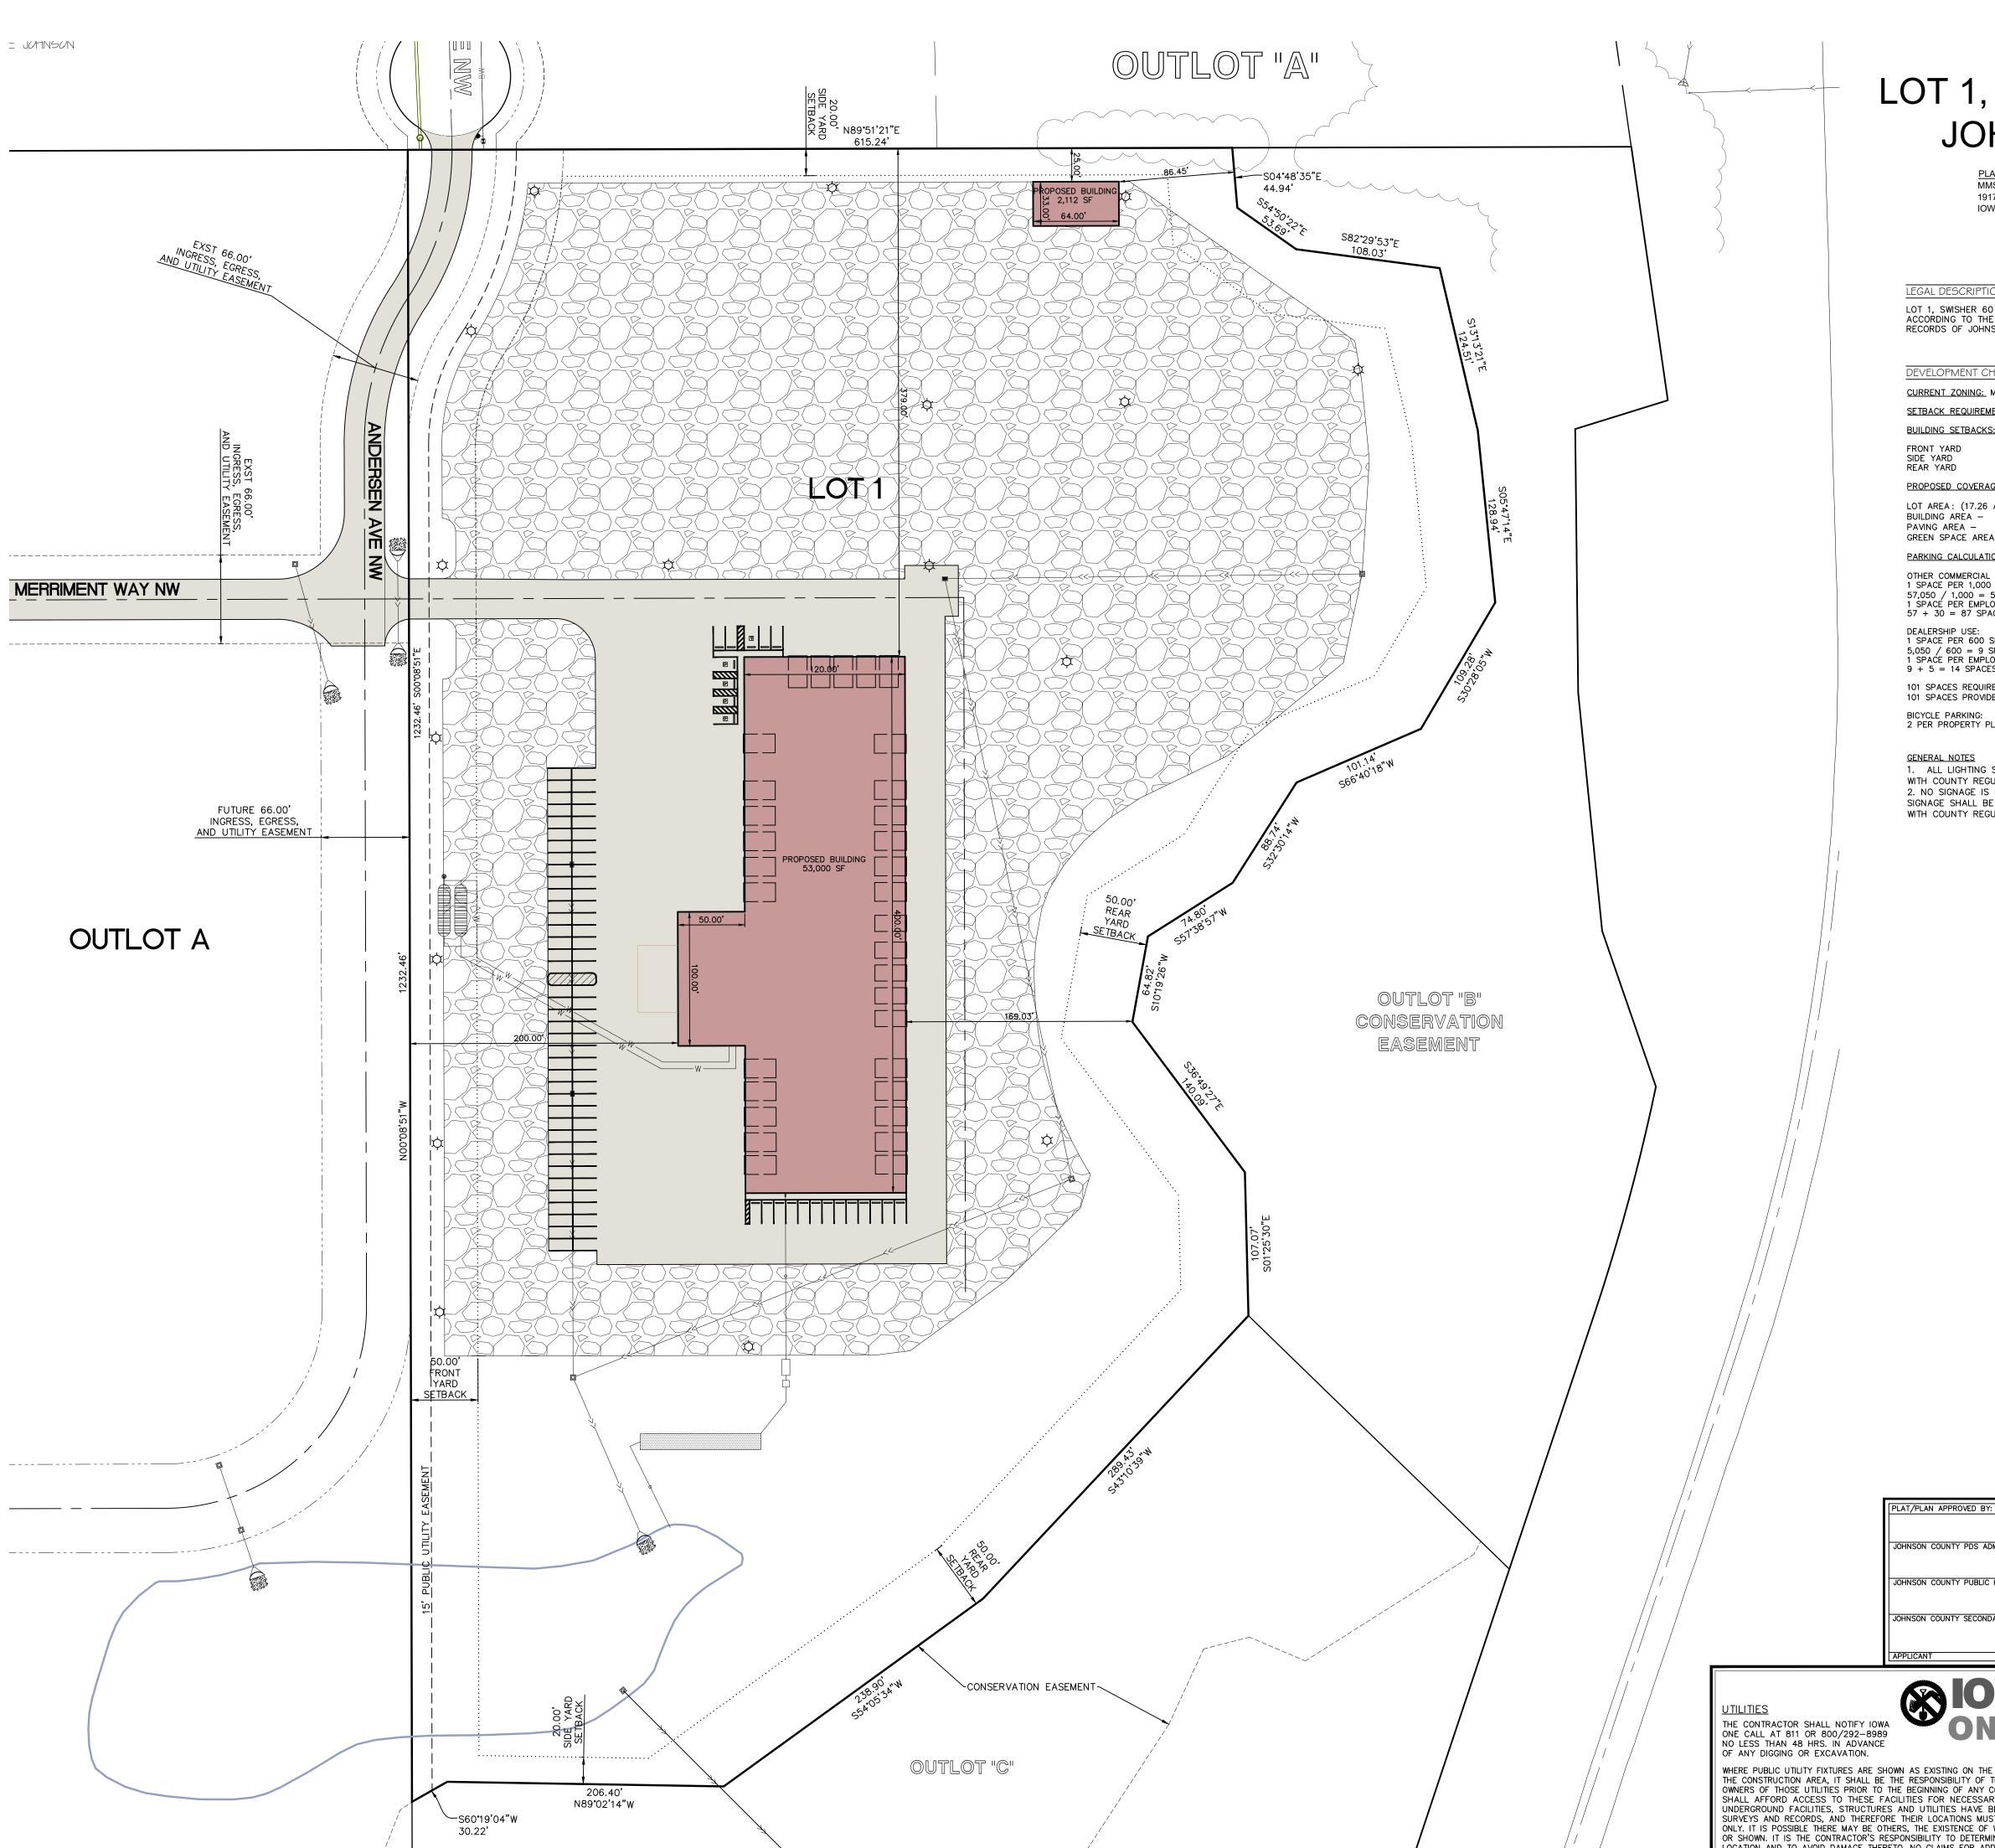2612 REC, LLC 1769 HAWTHORN LANE NE SOLON, IOWA 52333

LESLIE L. MOORE 320 KIRKWOOD AVE IOWA CITY, IOWA 52240

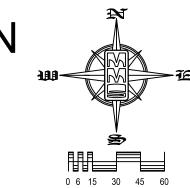

GRAPHIC SCALE IN FEET

LEGAL DESCRIPTION LOT 1, SWISHER 60 SUBDIVISION, JOHNSON COUNTY, IOWA, ACCORDING TO THE PLAT THEREOF RECORDED IN THE PLAT

RECORDS OF JOHNSON COUNTY, IOWA.

DEVELOPMENT CHARACTERISTICS CURRENT ZONING: ML (LIGHT INDUSTRIAL) SETBACK REQUIREMENTS: **BUILDING SETBACKS:** REQUIRED: 50 FEET 20 FEET 50 FEET FRONT YARD SIDE YARD REAR YARD

PROPOSED COVERAGE: 751,991 SF (100%) 55,112 SF (7.3%) 432,891 SF (57.6%) LOT AREA: (17.26 AC.) BUILDING AREA -PAVING AREA -GREEN SPACE AREA -264,492 SF (35.2%)

PARKING CALCULATIONS: OTHER COMMERCIAL USE (SERVICE): 1 SPACE PER 1,000 SF BUILDING AREA 1 SPACE PER EMPLOYEE OF LARGEST SHIFT = 30 SPACES 57 + 30 = 87 SPACES

DEALERSHIP USE:

1 SPACE PER 600 SF BUILDING AREA

5,050 / 600 = 9 SPACES

1 SPACE PER EMPLOYEE = 5 SPACES

9 + 5 = 14 SPACES

101 SPACES REQUIRED 101 SPACES PROVIDED (5 ADA SPACES)

BICYCLE PARKING: 2 PER PROPERTY PLUS 2 FOR EVERY 50 REQUIRED PARKING SPACES — 6 REQUIRED

GENERAL NOTES 1. ALL LIGHTING SHALL BE IN ACCORDANCE WITH COUNTY REGULATION. 2. NO SIGNAGE IS PROPOSED, ANY FUTURE SIGNAGE SHALL BE INSTALLED IN ACCORDANCE WITH COUNTY REGULATION.


### SHEET INDEX

SITE LAYOUT & DIMENSION PLAN DETAILED SITE DIMENSION PLAN SITE GRADING PLAN AND SWPPP DETAILED SITE GRADING PLAN: NORTH C142 DETAILED SITE GRADING PLAN: SOUTH C160 SITE UTILITY PLAN C161 SEPTIC DESIGN GENERAL NOTES AND DETAILS C500 SITE LANDSCAPE PLAN CL100 PAVING PLAN AND PROFILE: MERRIMENT WAY NW

PAVING PLAN AND PROFILE: ANDERSEN AVE NW INTERSECTION DETAIL: HIGHWAY 965

NW & MERRIMENT WAY NW INTERSECTION DETAIL: MERRIMENT WAY NW & ANDERSEN AVE NW INTERSECTION DETAIL: ANDERSEN AVE

NW CONNECTION

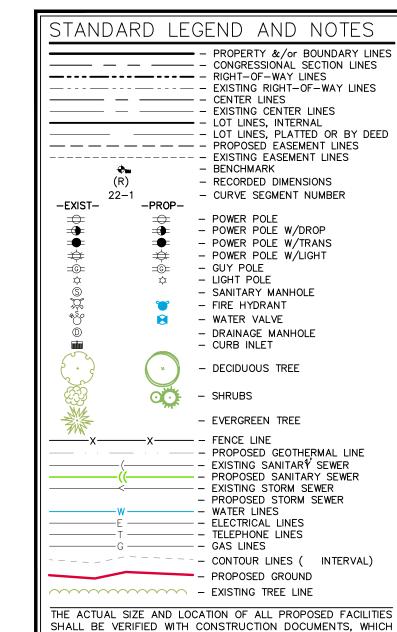

ARE TO BE PREPARED AND SUBMITTED SUBSEQUENT TO THE

APPROVAL OF THIS DOCUMENT.

LOT 1, SWISHER 60 SUBDIVISION JOHNSON COUNTY, IOWA

SITE LAYOUT

LOT 1, SWISHER 60 SUBDIVISION

JOHNSON COUNTY

LOCATION MAP

NOT TO SCALE

JOHNSON COUNTY PDS ADMINISTRATOR

JOHNSON COUNTY PUBLIC HEALTH DEPT. COORD. DATE

JOHNSON COUNTY SECONDARY ROADS COORDINATOR DATE

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ALLOWED TO THE CONTRACTOR FOR ANY INTERFERENCE OR DELAY CAUSED BY SUCH WORK.

I hereby certify that this engineering document was prepared by me or under my direct supervision and that am a duly licensed Professional Engineer under the laws of the State of Iowa. CHRISTOPHER THOMPSON

MMS CONSULTANTS, INC. 03-20-2024 Designed by: Drawn by:

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LAND SURVEYORS

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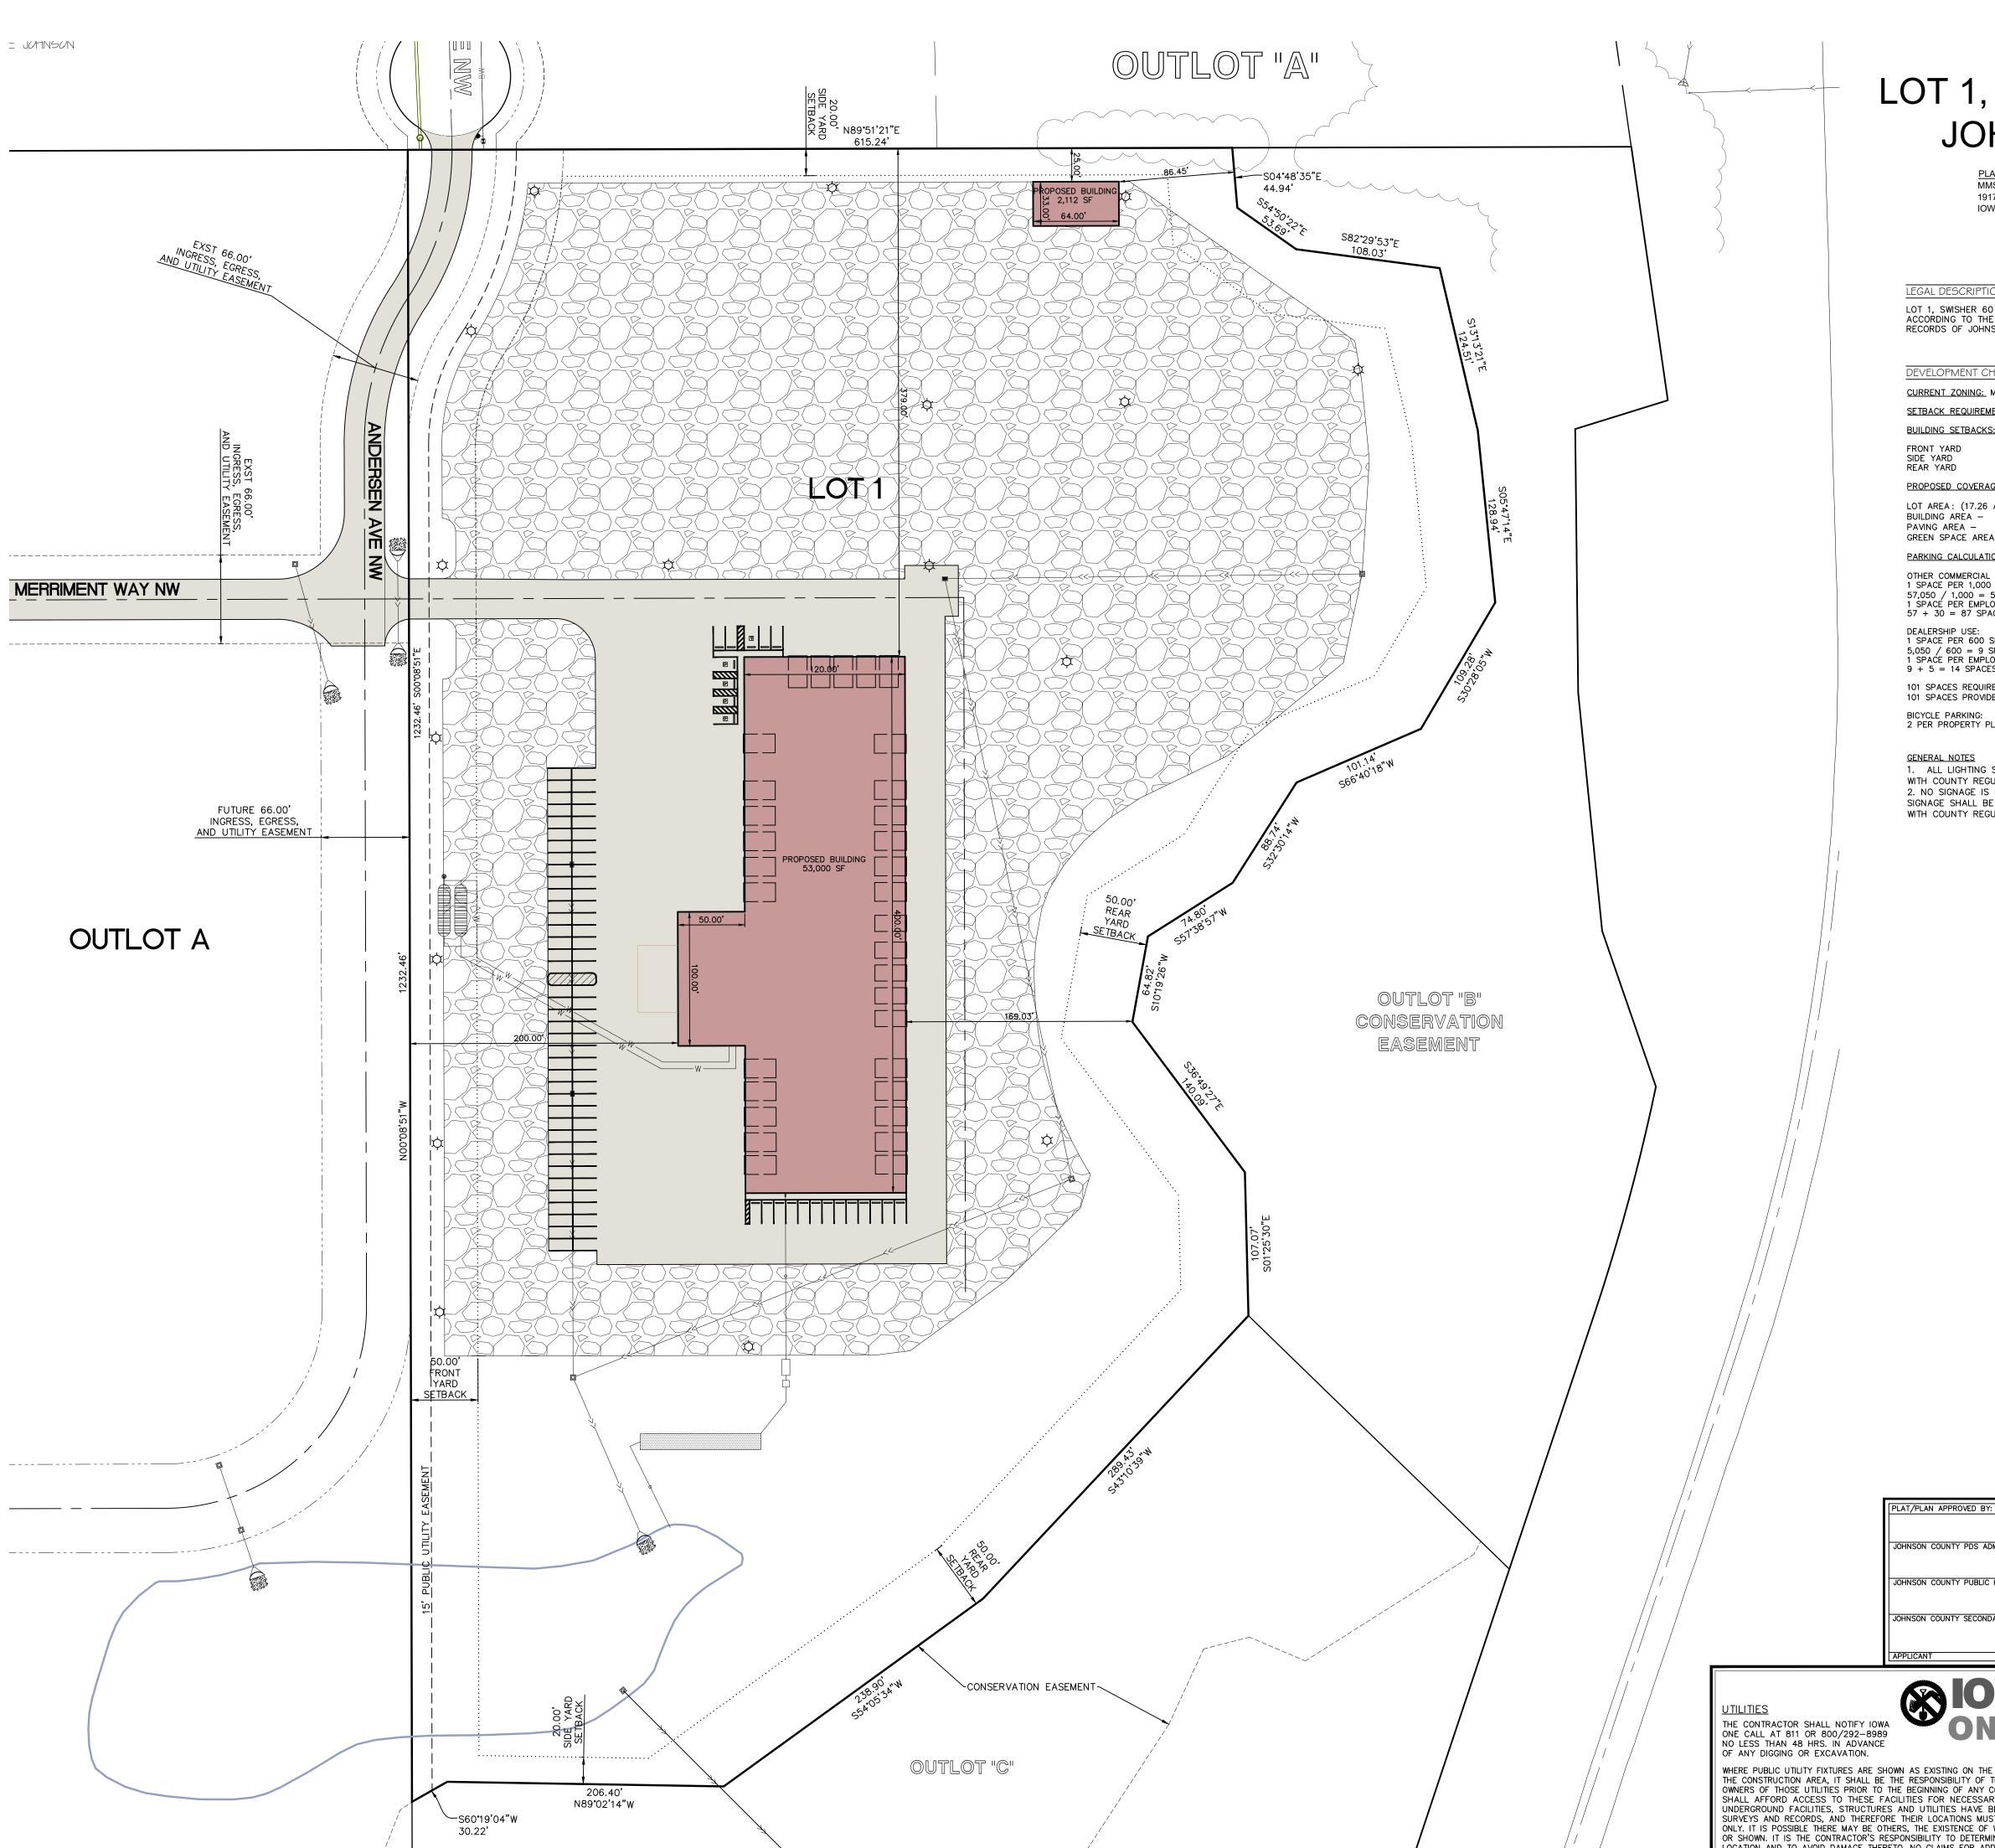
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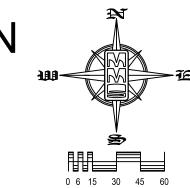


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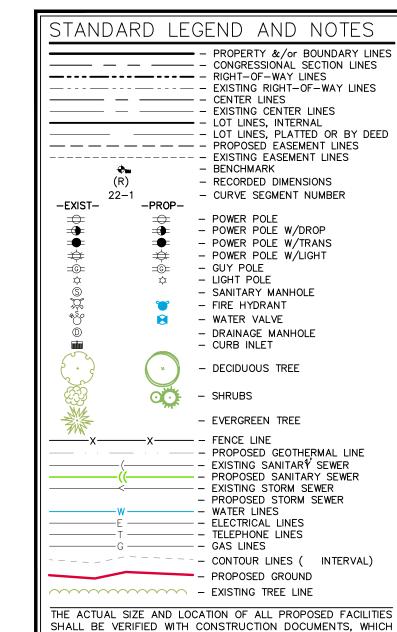
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LOT 1, SWISHER 60 SUBDIVISION JOHNSON COUNTY, IOWA

SITE LAYOUT

LOT 1, SWISHER 60 SUBDIVISION

JOHNSON COUNTY

LOCATION MAP

NOT TO SCALE

JOHNSON COUNTY PDS ADMINISTRATOR

JOHNSON COUNTY PUBLIC HEALTH DEPT. COORD. DATE


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I hereby certify that this engineering document was prepared by me or under my direct supervision and that am a duly licensed Professional Engineer under the laws of the State of Iowa. CHRISTOPHER THOMPSON

MMS CONSULTANTS, INC. 03-20-2024 Designed by: Drawn by:



0 4 10 20 30 40 GRAPHIC SCALE IN FEET

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<u>PLAN PREPARED BY:</u> MMS CONSULTANTS INC. 1917 S. GILBERT STREET IOWA CITY, IOWA 52240

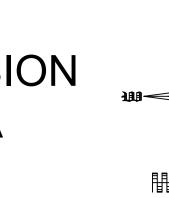2,112 SF

104

LOT 1

ROPOSED BUILDING 53,000 SF

**1**8.00'(TYP.)

50.00'

FRONT YARD SETBACK

104

 $(104)^{-}$ 

(104)

CONSERVATION EASEMENT

EASEMENT

REAR YARD SETBACK

1769 HAWTHORN LANE NE SOLON, IOWA 52333


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ANDERSEN AVE NW INTERSECTION DETAIL: HIGHWAY 965 NW & MERRIMENT WAY NW INTERSECTION DETAIL: MERRIMENT WAY NW & ANDERSEN AVE NW

INTERSECTION DETAIL: ANDERSEN AVE NW CONNECTION





## 7" PCC OVER 6" ROCK BASE. PAVEMENT SHALL SUPPORT AT LEAST 75,000 LBS. (98,349 SF) ASPHALT MILLINGS (335,275 SF) NOTE: CALCULATED PAVING AREAS LISTED ON THIS LEGEND INCLUDE AREAS WHICH ARE LOCATED BEYOND LOT 1 BOUNDARY

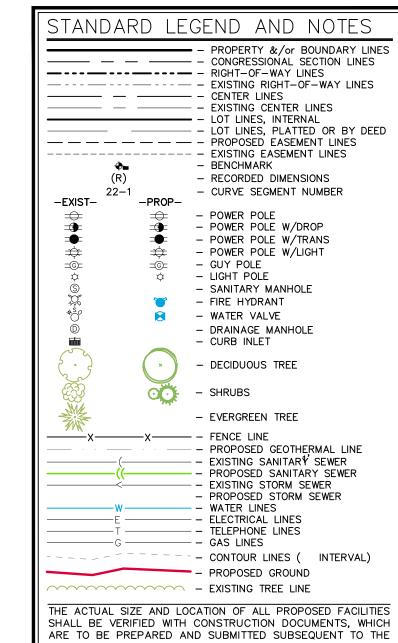KEYNOTES			
NUMBER	KEYNOTE	DETAIL	
101	PROPOSED PAVEMENT (THICKNESS AND MATERIAL AS NOTED IN PAVEMENT LEGEND ABOVE)		
102	PROPOSED 4" WIDE PAVEMENT MARKING		
103	PROPOSED OVERHEAD DOOR LOCATION		
104	INSTALL LIGHT POLE		
105	PROPOSED ADA STRIPING AND SIGNAGE		
106			

UTILITIES  THE CONTRACTOR SHALL NOTIFY IOWA ONE CALL AT 811 OR 800/292-8989 NO LESS THAN 48 HRS. IN ADVANCE OF ANY DIGGING OR EXCAVATION.	S IOWA SILE ONE CALL SA

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	MMS CON	SU	LTANT	S, IN
.	Date:		03-20	-202
HIN HE FOR ES.	Designed by: CAT/L	.SS	Field Book N	No:
	Drawn by: A	.DP	Scale:	1"=4
	Checked by:	:AT	Sheet No:	
TE	Project No:			

**OFF:SHEET** 

LOT 1, SWISHER 60 SUBDIVISION

JOHNSON COUNTY IOWA

CIVIL ENGINEERS

LAND PLANNERS LAND SURVEYORS LANDSCAPE ARCHITECTS **ENVIRONMENTAL SPECIALISTS** 1917 S. GILBERT ST. IOWA CITY, IOWA 52240 (319) 351-8282 www.mmsconsultants.net

DETAILED SITE DIMENSION PLAN APPROVAL OF THIS DOCUMENT.





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1769 HAWTHORN LANE NE

320 KIRKWOOD AVE IOWA CITY, IOWA 52240



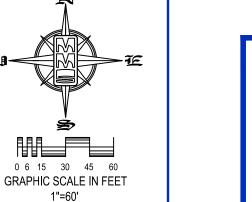

## GRADING AND EROSION CONTROL NOTES

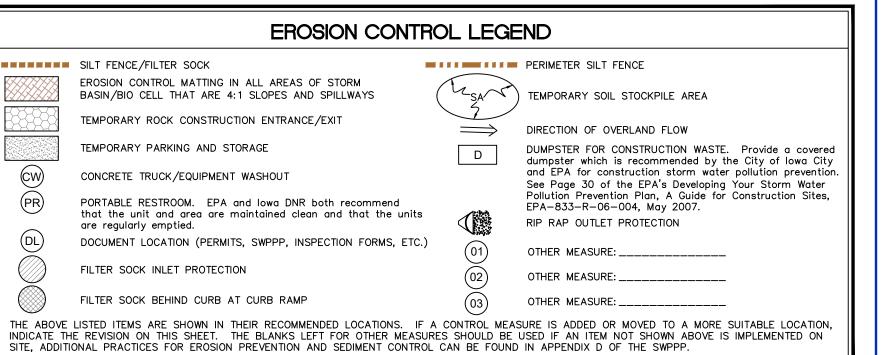TOTAL SITE AREA: 17.26 ACRES TOTAL AREA TO BE DISTURBED: 17.26 ACRES

EROSION CONTROL MEASURES SHOWN SHALL BE USED DURING FILL ACTIVITIES. EROSION CONTROL MEASURES SHALL BE REEVALUATED AND MODIFIED, IF NECESSARY, AT THE TIME OF SITE DEVELOPMENT.

ADDITIONAL EROSION AND SEDIMENT CONTROL MEASURES THAT COULD BE USED ON SITE, IF NEEDED, CAN BE FOUND IN APPENDIX D OF THE STORM WATER POLLUTION PREVENTION PLAN (SWPPP) BINDER PREPARED FOR THE SITE. IF ADDITIONAL MEASURES ARE USED, INDICATE THE TYPE AND LOCATION OF SAID MEASURE ON THIS PLAN.

CONTRACTOR SHALL INSTALL A ROCK ENTRANCE AND PERFORM REGULAR CLEANING OF VEHICLES THAT LEAVE THE SITE.


# CONSTRUCTION ENTRANCE THE CONTRACTOR SHALL CONTACT THE CITY INSPECTOR TO SCHEDULE A SITE INSPECTION PRIOR TO ANY SOIL

THE CONTRACTOR SHALL FOLLOW THE NPDES PERMIT, SWPPP, AND THE COUNTY CSR REGULATIONS. THE EROSION CONTROL CONTRACTOR SHALL INSTALL FILTER SOCKS OR OTHER APPROVED FORM OF INLET PROTECTION AT EACH STREET INTAKE ADJACENT TO THE SITE.

EROSION CONTROL MEASURES, INCLUDING, BUT NOT LIMITED TO, TEMPORARY ROCK CONSTRUCTION ENTRANCE, CONCRETE WASHOUT, TEMPORARY PARKING AREA, AND STORAGE AREAS. SHALL BE CONSTRUCTED IN ACCORDANCE WITH SECTION 9040 SUDAS STANDARD SPECIFICATIONS.

DUE TO PHASED CONSTRUCTION OF DRIVE AND BUILDING, EROSION CONTROL MEASURES SHALL BE INSTALLED AND MAINTAINED BASED ON THE PHASE AND EXTENTS OF LAND DISTURBANCE. CONTRACTOR SHALL COORDINATE WITH COUNTY AND THAT ALL DISTURBED AREAS ARE STABILIZED IN ACCORDANCE WITH JOHNSON COUNTY ENVIRONMENTAL

## SILT FENCE DETAIL

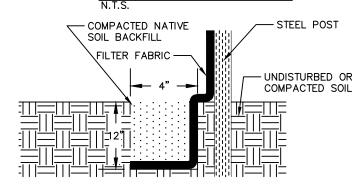

POSTS SHALL BE 1.33 POUNDS PER LINEAL FOOT STEEL WITH A MINIMUM LENGTH OF 5 FEET. STEEL POSTS SHALL HAVE PROJECTIONS FOR FASTENING WIRE TO THEM. SILT FENCE FABRIC SHALL CONFORM TO I.D.O.T. STANDARD SPECIFICATION SECTION 4196.01.A. SILT FENCING SHALL BE A MINIMUM OF 24" AND A MAXIMUM OF 36" HIGH WHEN

THE FILTER FABRIC SHALL BE PURCHASED IN A CONTINUOUS

- ROLL CUT TO THE LENGTH OF THE FENCE TO AVOID THE USE OF JOINTS. WHEN JOINTS ARE NECESSARY, THE FILTER CLOTH SHALL BE SPLICED TOGETHER ONLY AT A SUPPORT POST, WITH A MINIMUM 6" OVERLAP, AND SECURELY SEALED. POSTS SHALL BE SPACED A MAXIMUM OF 8 FEET APART AND DRIVEN SECURELY INTO THE GROUND ALONG THE FENCE ALIGNMENT. POSTS SHALL BE DRIVEN INTO THE GROUND A MINIMUM OF 28". A TRENCH SHALL BE EXCAVATED APPROXIMATELY 4" WIDE BY 12" DEEP ALONG THE UPSLOPE SIDE OF THE POSTS.
- FILTER FABRIC SHALL BE STAPLED OR WIRED TO THE POSTS SUCH THAT THE FABRIC EXTENDS INTO THE TRENCH AS MINIMUM OF THREE PLACES ON EACH POST. THE TRENCH SHALL BE BACK FILLED WITH EXCAVATED MATERIAL AND THOROUGHLY COMPACTED.
- MAINTENANCE SILT FENCES SHALL BE INSPECTED WEEKLY AND AFTER EACH RAIN-FALL EVENT PRODUCING RUN-OFF. DURING PERIODS OF PROLONGED RAIN INSPECTIONS SHALL BE AT LEAST DAILY. ANY REPAIRS NEEDED TO MAINTAIN THE SILT FENCE'S
- EFFECTIVENESS SHALL BE MADE IMMEDIATELY. SHOULD THE FABRIC ON A SILT FENCE DECOMPOSE OR BECOME INEFFECTIVE PRIOR TO STABILIZING THE UPSLOPE AREAS THE FABRIC SHALL BE REPLACED PROMPTLY.
- SEDIMENT DEPOSITS SHOULD BE REMOVED AFTER EACH STORM EVENT. THEY MUST BE REMOVED WHEN THE DEPOSITS REACH APPROXIMATELY ONE—HALF THE HEIGHT OF THE FENCE. SILTS REMOVED SHALL BE PLACED IN A PROTECTED PLACE THAT WILL PREVENT THEIR ESCAPE FROM THE CONSTRUCTION SITE.
- 4. ANY SEDIMENT DEPOSITS REMAINING IN PLACE AFTER THE SILT FENCE IS NO LONGER NEEDED SHALL BE DRESSED TO CONFORM WITH THE EXISTING GRADE, PREPARED AND

#### SILT FENCE SHALL REMAIN IN PLACE UNTIL IT IS NO LONGER NEEDED AS DIRECTED BY THE POLLUTION PREVENTION PLAN. GENERALLY SILT FENCES SHALL REMAIN UNTIL THE UPSLOPE AREAS ARE STABILIZED WITH AN ESTABLISHED GRASS COVER AS A MINIMUM.

STANDARD LEGEND AND NOTES

## STABILIZATION SEEDING

STABILIZATION SEEDING SHALL BE IN ACCORDANCE WITH SUDAS SECTION 9010.2.02 SEED MIXTURES AND SEEDING DATES. TABLE 9010.06: TYPE 4 SEED MIXTURE APPLICATION RATE lb/acre COMMON NAME SPRING - MARCH 1 - MAY 20 ANNUAL RYEGRASS 40 65 SUMMER - MAY 21 - AUGUST 14 ANNUAL RYEGRASS 50 95 FALL - AUGUST 15 - SEPTEMBER 30 ANNUAL RYEGRASS GRAIN RYF 65 ENGINEER MAY DELETE FOR PREVIOUSLY ESTABLISHED URBAN AREAS. FERTILIZER SHALL BE APPLIED AT A RATE OF 300 LBS PER ACRE USING CHEMICALLY COMBINED COMMERCIAL 13-13-13 FERTILIZER (SUDAS SECTION 9010.2.03 A.2)

THE CONTRACTOR SHALL NOTIFY IOWA ONE CALL AT 811 OR 800/292-8989 NO LESS THAN 48 HRS. IN ADVANCE

INTERSECTION DETAIL: ANDERSEN AVE

NW CONNECTION

WHERE PUBLIC UTILITY FIXTURES ARE SHOWN AS EXISTING ON THE PLANS OR ENCOUNTERED WITHIN THE CONSTRUCTION AREA, IT SHALL BE THE RESPONSIBILITY OF THE CONTRACTOR TO NOTIFY THE OWNERS OF THOSE UTILITIES PRIOR TO THE BEGINNING OF ANY CONSTRUCTION. THE CONTRACTOR SHALL AFFORD ACCESS TO THESE FACILITIES FOR NECESSARY MODIFICATION OF SERVICES. UNDERGROUND FACILITIES, STRUCTURES AND UTILITIES HAVE BEEN PLOTTED FROM AVAILABLE SURVEYS AND RECORDS, AND THEREFORE THEIR LOCATIONS MUST BE CONSIDERED APPROXIMATE ONLY. IT IS POSSIBLE THERE MAY BE OTHERS, THE EXISTENCE OF WHICH IS PRESENTLY NOT KNOWN OR SHOWN, IT IS THE CONTRACTOR'S RESPONSIBILITY TO DETERMINE THEIR EXISTENCE AND EXACT LOCATION AND TO AVOID DAMAGE THERETO. NO CLAIMS FOR ADDITIONAL COMPENSATION WILL BE ALLOWED TO THE CONTRACTOR FOR ANY INTERFERENCE OR DELAY CAUSED BY SUCH WORK.

—————————————————————————————————————	- CONGRESSIONAL SECTION LINES - RIGHT-OF-WAY LINES - EXISTING RIGHT-OF-WAY LINES - CENTER LINES - EXISTING CENTER LINES - LOT LINES, INTERNAL - LOT LINES, PLATTED OR BY DEED - PROPOSED EASEMENT LINES - EXISTING EASEMENT LINES - BENCHMARK
—————————————————————————————————————	- EXISTING RIGHT-OF-WAY LINES - CENTER LINES - EXISTING CENTER LINES - LOT LINES, INTERNAL - LOT LINES, PLATTED OR BY DEED - PROPOSED EASEMENT LINES - EXISTING EASEMENT LINES
	- CENTER LINES - EXISTING CENTER LINES - LOT LINES, INTERNAL - LOT LINES, PLATTED OR BY DEED - PROPOSED EASEMENT LINES - EXISTING EASEMENT LINES
	- EXISTING CENTER LINES - LOT LINES, INTERNAL - LOT LINES, PLATTED OR BY DEED - PROPOSED EASEMENT LINES - EXISTING EASEMENT LINES
	- LOT LINES, INTERNAL - LOT LINES, PLATTED OR BY DEED - PROPOSED EASEMENT LINES - EXISTING EASEMENT LINES
	- LOT LINES, PLATTED OR BY DEED - PROPOSED EASEMENT LINES - EXISTING EASEMENT LINES
	- EXISTING EASEMENT LINES
	- EXISTING EASEMENT LINES
	<ul><li>BENCHMARK</li></ul>
(D)	
(R)	<ul> <li>RECORDED DIMENSIONS</li> </ul>
22-1	<ul> <li>CURVE SEGMENT NUMBER</li> </ul>
-EXISTPROP-	
<del>=</del> =	- POWER POLE
<b>→</b>	- POWER POLE W/DROP
<b>→</b>	- POWER POLE W/TRANS
* *	- POWER POLE W/LIGHT
-©- -©-	- GUY POLE
ф ©	- LIGHT POLE
	- SANITARY MANHOLE
**************************************	- FIRE HYDRANT
Ö	<ul><li>WATER VALVE</li></ul>
<u>©</u>	- DRAINAGE MANHOLE
	- CURB INLET
§ . ? (x)	- DECIDUOUS TREE
	- SHRUBS
	- EVERGREEN TREE
xx	- FENCE LINE
: `` : ``	- PROPOSED GEOTHERMAL LINE
	- EXISTING SANITAR∜ SEWER - PROPOSED SANITARY SEWER
( <u>(</u>	- PROPOSED SANITARY SEWER
<del></del>	- EXISTING STORM SEWER
NA.	- PROPOSED STORM SEWER - WATER LINES
	- WATER LINES - ELECTRICAL LINES
T	- ELECTRICAL LINES - TELEPHONE LINES
Ġ	- GAS LINES
	- CONTOUR LINES ( INTERVAL)
	- PROPOSED GROUND
······	- EXISTING TREE LINE
	22

ARE TO BE PREPARED AND SUBMITTED SUBSEQUENT TO THE

APPROVAL OF THIS DOCUMENT.

# CIVIL ENGINEERS LAND PLANNERS LAND SURVEYORS

LANDSCAPE ARCHITECTS **ENVIRONMENTAL SPECIALISTS** 1917 S. GILBERT ST. IOWA CITY, IOWA 52240 (319) 351-8282 www.mmsconsultants.net

SITE GRADING PLAN **AND SWPPP** 

LOT 1, SWISHER 60 SUBDIVISION

JOHNSON COUNTY

MMS CONSULTANTS, INC. 03-20-2024 CAT/LSS Checked by:

LAND PLANNERS

LAND SURVEYORS

1917 S. GILBERT ST.


(319) 351-8282

IOWA CITY, IOWA 52240

www.mmsconsultants.net

LANDSCAPE ARCHITECTS

**ENVIRONMENTAL SPECIALISTS** 

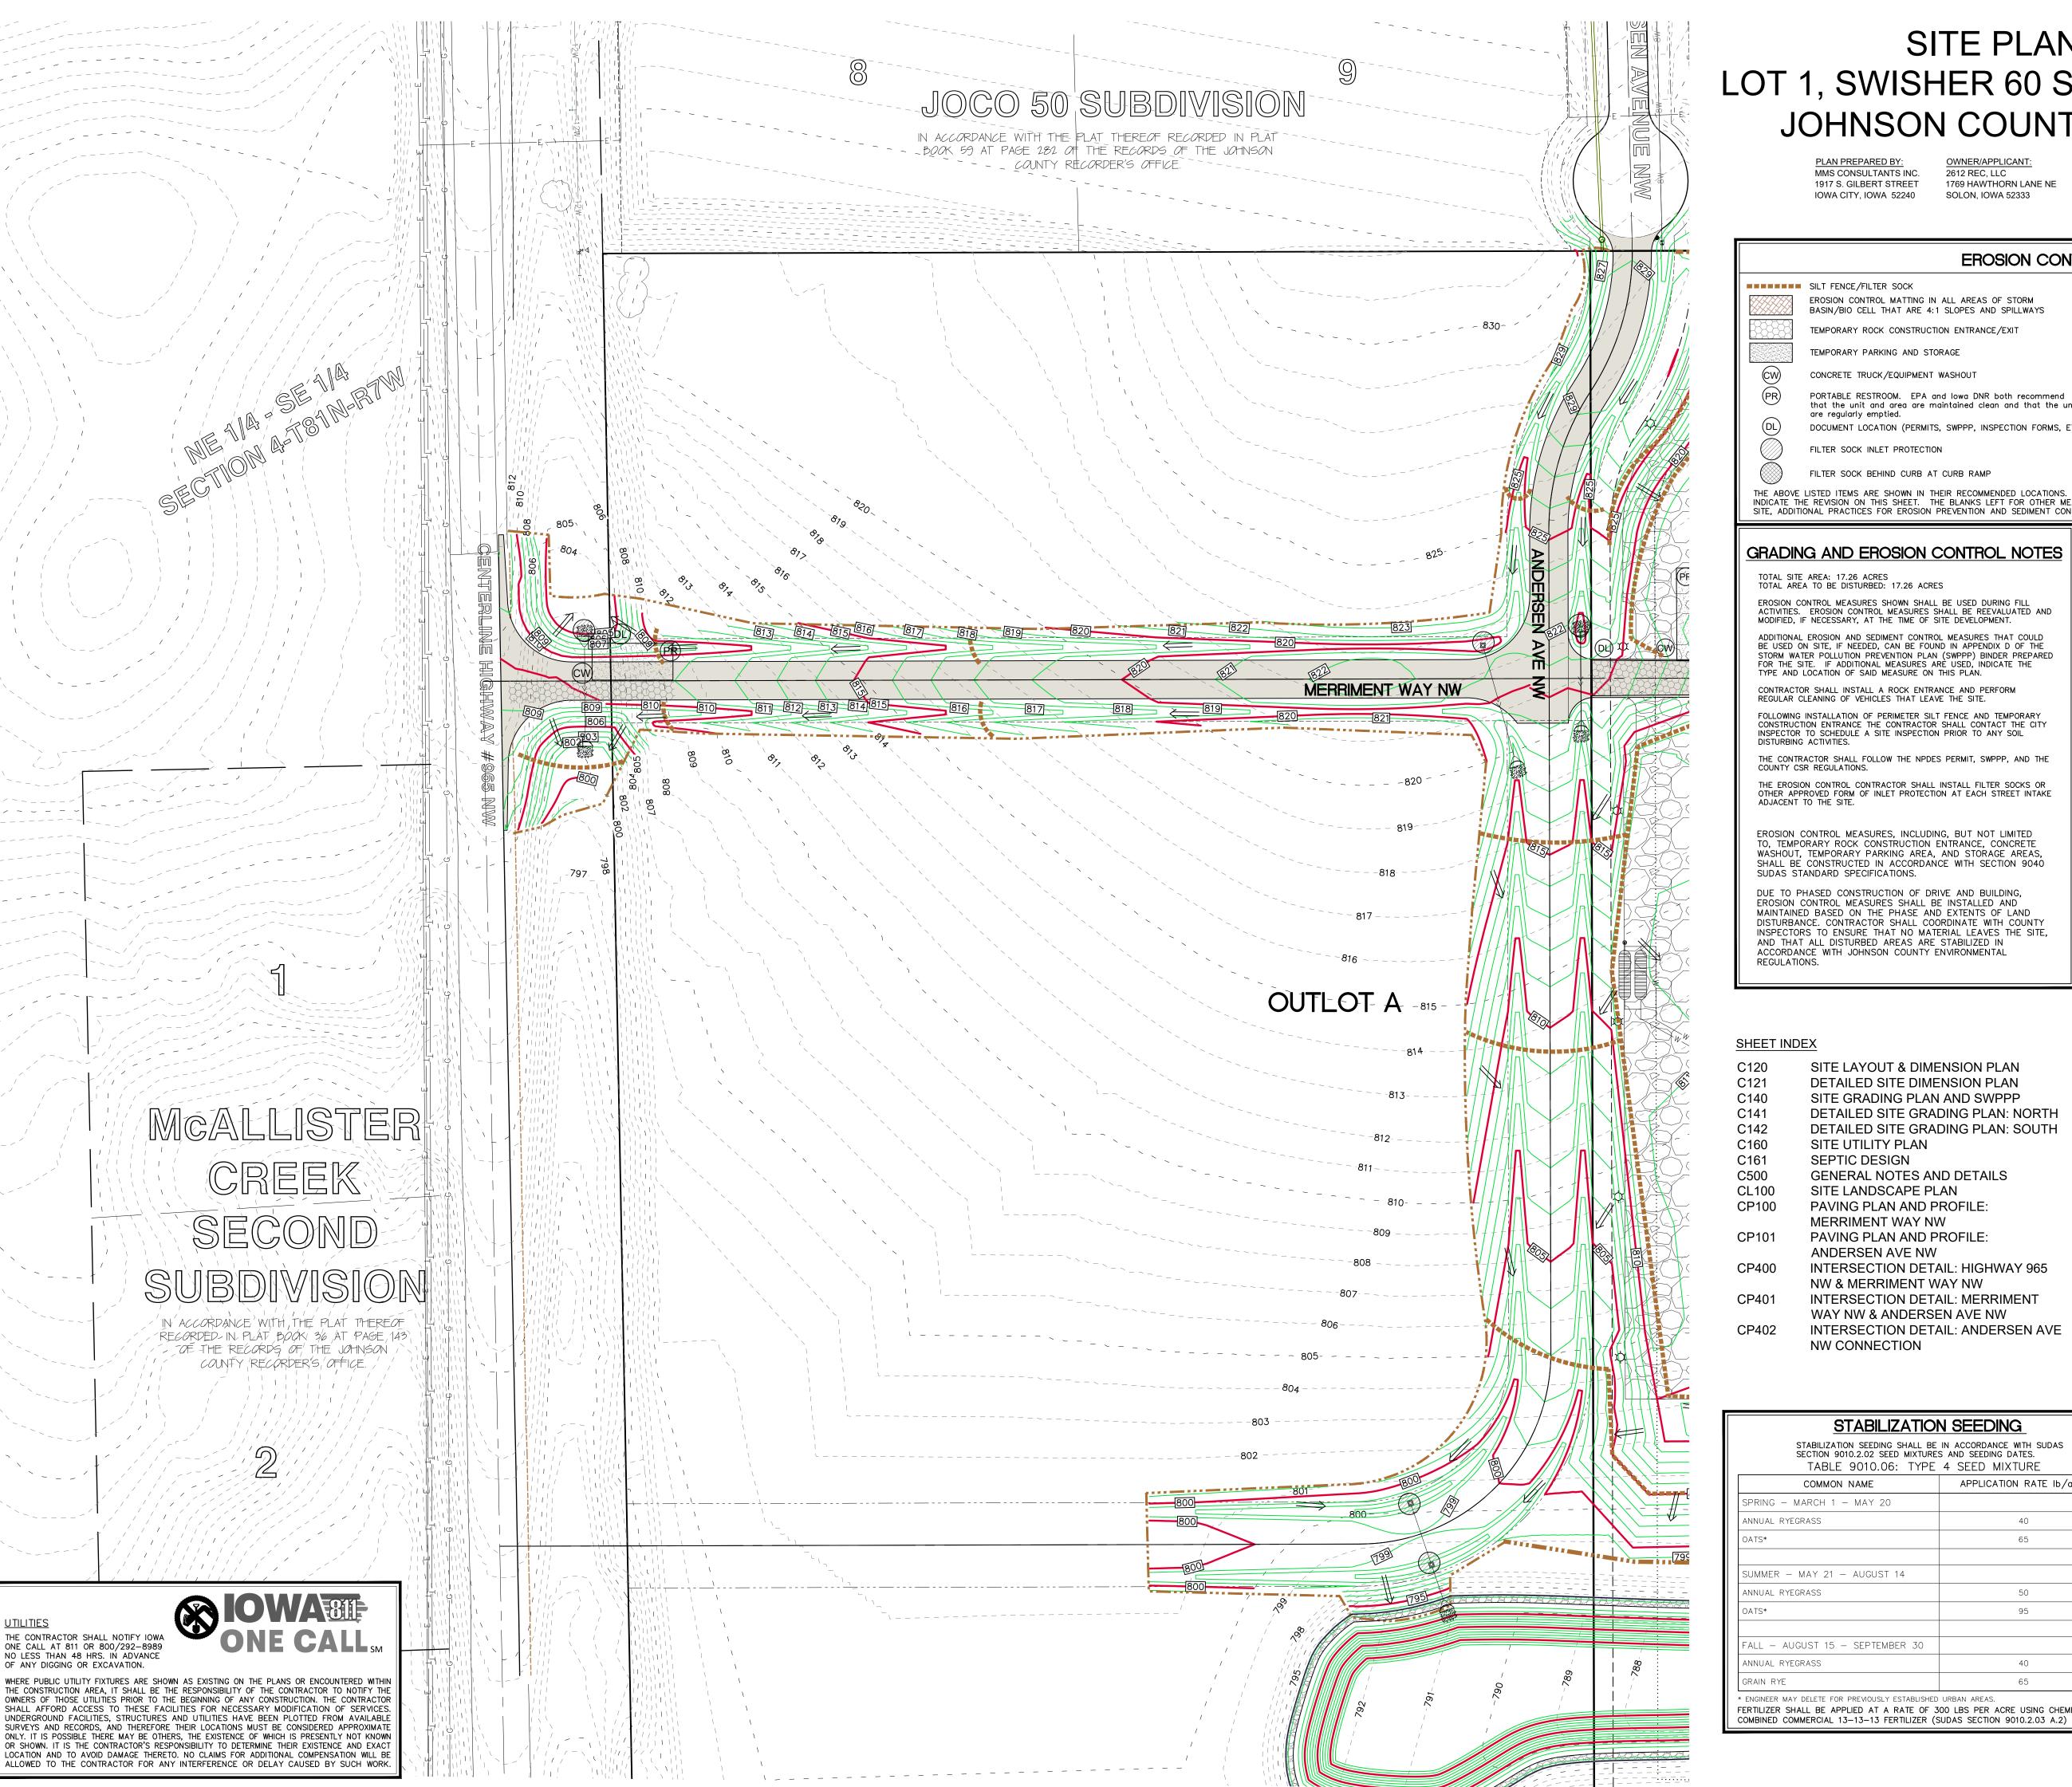


# SITE PLAN LOT 1, SWISHER 60 SUBDIVISION JOHNSON COUNTY, IOWA

MMS CONSULTANTS INC. 1917 S. GILBERT STREET


SILT FENCE/FILTER SOCK

1769 HAWTHORN LANE NE SOLON, IOWA 52333

320 KIRKWOOD AVE IOWA CITY, IOWA 52240

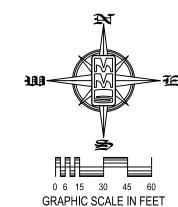

1"=60'

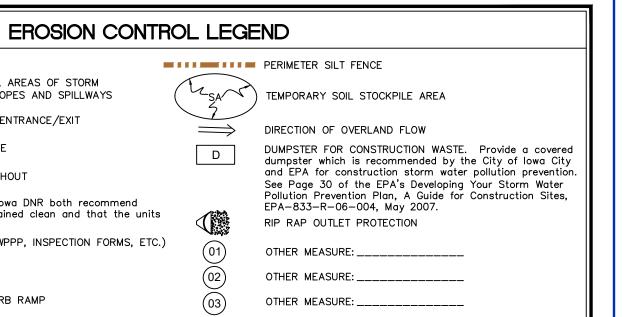

INDICATE THE REVISION ON THIS SHEET. THE BLANKS LEFT FOR OTHER MEASURES SHOULD BE USED IF AN ITEM NOT SHOWN ABOVE IS IMPLEMENTED ON SITE, ADDITIONAL PRACTICES FOR EROSION PREVENTION AND SEDIMENT CONTROL CAN BE FOUND IN APPENDIX D OF THE SWPPP.

THE ABOVE LISTED ITEMS ARE SHOWN IN THEIR RECOMMENDED LOCATIONS. IF A CONTROL MEASURE IS ADDED OR MOVED TO A MORE SUITABLE LOCATION,

# GRADING AND EROSION CONTROL NOTES

FILTER SOCK BEHIND CURB AT CURB RAMP

EROSION CONTROL MATTING IN ALL AREAS OF STORM BASIN/BIO CELL THAT ARE 4:1 SLOPES AND SPILLWAYS

PORTABLE RESTROOM. EPA and lowa DNR both recommend

that the unit and area are maintained clean and that the units

DOCUMENT LOCATION (PERMITS, SWPPP, INSPECTION FORMS, ETC.)

TEMPORARY ROCK CONSTRUCTION ENTRANCE/EXIT

TEMPORARY PARKING AND STORAGE

are regularly emptied.

FILTER SOCK INLET PROTECTION

CONCRETE TRUCK/EQUIPMENT WASHOUT

TOTAL SITE AREA: 17.26 ACRES TOTAL AREA TO BE DISTURBED: 17.26 ACRES EROSION CONTROL MEASURES SHOWN SHALL BE USED DURING FILL ACTIVITIES. EROSION CONTROL MEASURES SHALL BE REEVALUATED AND MODIFIED, IF NECESSARY, AT THE TIME OF SITE DEVELOPMENT. BE USED ON SITE, IF NEEDED, CAN BE FOUND IN APPENDIX D OF THE STORM WATER POLLUTION PREVENTION PLAN (SWPPP) BINDER PREPARED FOR THE SITE. IF ADDITIONAL MEASURES ARE USED, INDICATE THE TYPE AND LOCATION OF SAID MEASURE ON THIS PLAN. CONTRACTOR SHALL INSTALL A ROCK ENTRANCE AND PERFORM

## REGULAR CLEANING OF VEHICLES THAT LEAVE THE SITE. CONSTRUCTION ENTRANCE THE CONTRACTOR SHALL CONTACT THE CITY INSPECTOR TO SCHEDULE A SITE INSPECTION PRIOR TO ANY SOIL

THE CONTRACTOR SHALL FOLLOW THE NPDES PERMIT, SWPPP, AND THE COUNTY CSR REGULATIONS. THE EROSION CONTROL CONTRACTOR SHALL INSTALL FILTER SOCKS OR OTHER APPROVED FORM OF INLET PROTECTION AT EACH STREET INTAKE ADJACENT TO THE SITE.

EROSION CONTROL MEASURES, INCLUDING, BUT NOT LIMITED TO, TEMPORARY ROCK CONSTRUCTION ENTRANCE, CONCRETE WASHOUT, TEMPORARY PARKING AREA, AND STORAGE AREAS, SHALL BE CONSTRUCTED IN ACCORDANCE WITH SECTION 9040 SUDAS STANDARD SPECIFICATIONS.

DUE TO PHASED CONSTRUCTION OF DRIVE AND BUILDING, EROSION CONTROL MEASURES SHALL BE INSTALLED AND MAINTAINED BASED ON THE PHASE AND EXTENTS OF LAND DISTURBANCE. CONTRACTOR SHALL COORDINATE WITH COUNTY AND THAT ALL DISTURBED AREAS ARE STABILIZED IN ACCORDANCE WITH JOHNSON COUNTY ENVIRONMENTAL REGULATIONS.

## SHEET INDEX


SITE LAYOUT & DIMENSION PLAN DETAILED SITE DIMENSION PLAN SITE GRADING PLAN AND SWPPP DETAILED SITE GRADING PLAN: NORTH DETAILED SITE GRADING PLAN: SOUTH SITE UTILITY PLAN SEPTIC DESIGN GENERAL NOTES AND DETAILS SITE LANDSCAPE PLAN PAVING PLAN AND PROFILE: MERRIMENT WAY NW PAVING PLAN AND PROFILE: ANDERSEN AVE NW INTERSECTION DETAIL: HIGHWAY 965 NW & MERRIMENT WAY NW INTERSECTION DETAIL: MERRIMENT

**NW CONNECTION** 

INTERSECTION DETAIL: ANDERSEN AVE

WAY NW & ANDERSEN AVE NW

STABILIZATION SEEDING  STABILIZATION SEEDING SHALL BE IN ACCORDANCE WITH SUDAS SECTION 9010.2.02 SEED MIXTURES AND SEEDING DATES.  TABLE 9010.06: TYPE 4 SEED MIXTURE		
SPRING - MARCH 1 - MAY 20		
ANNUAL RYEGRASS	40	
OATS*	65	
SUMMER - MAY 21 - AUGUST 14		
ANNUAL RYEGRASS	50	
OATS*	95	
FALL - AUGUST 15 - SEPTEMBER 30		
ANNUAL RYEGRASS	40	
GRAIN RYE	65	

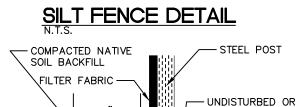

POSTS SHALL BE 1.33 POUNDS PER LINEAL FOOT STEEL WITH A MINIMUM LENGTH OF 5 FEET. STEEL POSTS SHALL HAVE

PROJECTIONS FOR FASTENING WIRE TO THEM. SILT FENCE FABRIC SHALL CONFORM TO I.D.O.T. STANDARD SPECIFICATION SECTION 4196.01.A. SILT FENCING SHALL BE A ROLL CUT TO THE LENGTH OF THE FENCE TO AVOID THE USE

SHALL BE SPLICED TOGETHER ONLY AT A SUPPORT POST, WITH A MINIMUM 6" OVERLAP, AND SECURELY SEALED. POSTS SHALL BE SPACED A MAXIMUM OF 8 FEET APART AND DRIVEN SECURELY INTO THE GROUND ALONG THE FENCE ALIGNMENT. POSTS SHALL BE DRIVEN INTO THE GROUND A MINIMUM OF 28". A TRENCH SHALL BE EXCAVATED APPROXIMATELY 4" WIDE BY 12" DEEP ALONG THE UPSLOPE SIDE OF THE POSTS. FILTER FABRIC SHALL BE STAPLED OR WIRED TO THE POSTS SUCH THAT THE FABRIC EXTENDS INTO THE TRENCH AS

MINIMUM OF THREE PLACES ON EACH POST. THE TRENCH SHALL BE BACK FILLED WITH EXCAVATED MATERIAL AND THOROUGHLY COMPACTED.


MAINTENANCE SILT FENCES SHALL BE INSPECTED WEEKLY AND AFTER EACH RAIN-FALL EVENT PRODUCING RUN-OFF. DURING PERIODS OF PROLONGED RAIN INSPECTIONS SHALL BE AT LEAST DAILY. ANY REPAIRS NEEDED TO MAINTAIN THE SILT FENCE'S EFFECTIVENESS SHALL BE MADE IMMEDIATELY. SHOULD THE FABRIC ON A SILT FENCE DECOMPOSE OR

BECOME INEFFECTIVE PRIOR TO STABILIZING THE UPSLOPE AREAS THE FABRIC SHALL BE REPLACED PROMPTLY. SEDIMENT DEPOSITS SHOULD BE REMOVED AFTER EACH STORM EVENT. THEY MUST BE REMOVED WHEN THE DEPOSITS REACH APPROXIMATELY ONE-HALF THE HEIGHT OF THE FENCE. SILTS REMOVED SHALL BE PLACED IN A PROTECTED PLACE THAT WILL PREVENT THEIR ESCAPE FROM THE CONSTRUCTION SITE. ANY SEDIMENT DEPOSITS REMAINING IN PLACE AFTER THE SILT FENCE IS NO LONGER NEEDED SHALL BE DRESSED TO

SILT FENCE SHALL REMAIN IN PLACE UNTIL IT IS NO LONGER NEEDED AS DIRECTED BY THE POLLUTION PREVENTION PLAN. GENERALLY SILT FENCES SHALL REMAIN UNTIL THE UPSLOPE AREAS ARE STABILIZED WITH AN ESTABLISHED GRASS COVER

STANDARD LEGEND AND NOTES

CONFORM WITH THE EXISTING GRADE, PREPARED AND

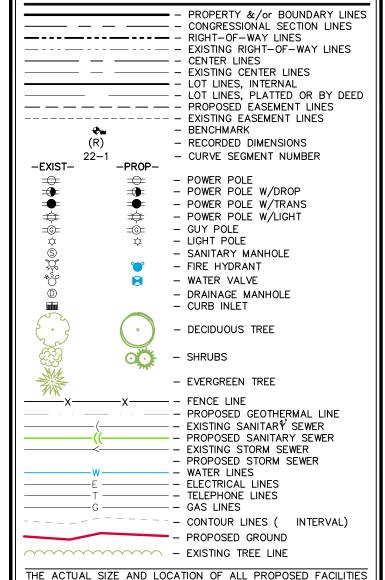

SHALL BE VERIFIED WITH CONSTRUCTION DOCUMENTS, WHICH

ARE TO BE PREPARED AND SUBMITTED SUBSEQUENT TO THE

APPROVAL OF THIS DOCUMENT.

# SITE GRADING PLAN **AND SWPPP**

LOT 1, SWISHER 60 SUBDIVISION

JOHNSON COUNTY

MS CONSULTANTS, INC.			
03-20-2024			
signed by: CAT/LSS	Field Book No:		
own by: ADP	Scale: 1"=60'		
ecked by: CAT	Sheet No:		
oject No:	C141		

LAND PLANNERS

LAND SURVEYORS

1917 S. GILBERT ST. IOWA CITY, IOWA 52240

(319) 351-8282

LANDSCAPE ARCHITECTS

ENVIRONMENTAL SPECIALISTS

UTILITIES

THE CONTRACTOR SHALL NOTIFY IOWA ONE CALL AT 811 OR 800/292-8989 NO LESS THAN 48 HRS. IN ADVANCE OF ANY DIGGING OR EXCAVATION.

WHERE PUBLIC UTILITY FIXTURES ARE SHOWN AS EXISTING ON THE PLANS OR ENCOUNTERED WITHIN WHERE PUBLIC UTILITY FIXTURES ARE SHOWN AS EXISTING ON THE PLANS OF ENCOUNTERED WITHIN THE CONSTRUCTION AREA, IT SHALL BE THE RESPONSIBILITY OF THE CONTRACTOR TO NOTIFY THE OWNERS OF THOSE UTILITIES PRIOR TO THE BEGINNING OF ANY CONSTRUCTION. THE CONTRACTOR SHALL AFFORD ACCESS TO THESE FACILITIES FOR NECESSARY MODIFICATION OF SERVICES. UNDERGROUND FACILITIES, STRUCTURES AND UTILITIES HAVE BEEN PLOTTED FROM AVAILABLE SURVEYS AND RECORDS, AND THEREFORE THEIR LOCATIONS MUST BE CONSIDERED APPROXIMATE. ONLY. IT IS POSSIBLE THERE MAY BE OTHERS, THE EXISTENCE OF WHICH IS PRESENTLY NOT KNOWN OR SHOWN. IT IS THE CONTRACTOR'S RESPONSIBILITY TO DETERMINE THEIR EXISTENCE AND EXACT LOCATION AND TO AVOID DAMAGE THERETO. NO CLAIMS FOR ADDITIONAL COMPENSATION WILL BE

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THE CONTRACTOR SHALL PROVIDE TRAFFIC CONTROL PER IDOT STANDARD ROAD PLANS AND JOHNSON COUNTY REQUIREMENTS AT ALL TIMES DURING WORK WITHIN PUBLIC R.O.W.

THE CONTRACTOR SHALL COORDINATE WITH UTILITY PROVIDERS FOR ANY REQUIRED RELOCATION OF EXISTING UTILITIES.

**GRADING LEGEND**  $\begin{array}{c} -000.00EX \\ \end{array} = EXISTING SURFACE$ 

 $\bullet$  000.00FG = FINISH GRADE

 $\bullet_{\overline{000.00TS}}$  = TOP SLAB  $\bullet$ 000.00TW = TOP WALK

 $\bullet$  000.00TC = TOP CURB  $\bullet$  000.00TR = TOP RIM

 $\bullet$  GOO.OOWT = FG AT TOP WALL  $\bullet_{\overline{000.00WB}}$  = FG AT BOTTOM WALL

# SITE PLAN LOT 1, SWISHER 60 SUBDIVISION JOHNSON COUNTY, IOWA

PLAN PREPARED BY: MMS CONSULTANTS INC. 1917 S. GILBERT STREET IOWA CITY, IOWA 52240

1769 HAWTHORN LANE NE SOLON, IOWA 52333

320 KIRKWOOD AVE IOWA CITY, IOWA 52240

### SHEET INDEX

DETAILED SITE DIMENSION PLAN SITE GRADING PLAN AND SWPPP C141 DETAILED SITE GRADING PLAN: NORTH DETAILED SITE GRADING PLAN: SOUTH C160 SITE UTILITY PLAN

SITE LAYOUT & DIMENSION PLAN

C161 SEPTIC DESIGN C500 GENERAL NOTES AND DETAILS

CL100 SITE LANDSCAPE PLAN PAVING PLAN AND PROFILE: MERRIMENT WAY NW PAVING PLAN AND PROFILE:


ANDERSEN AVE NW INTERSECTION DETAIL: HIGHWAY 965 NW & MERRIMENT WAY NW

INTERSECTION DETAIL: MERRIMENT WAY NW & ANDERSEN AVE NW

INTERSECTION DETAIL: ANDERSEN AVE NW CONNECTION

GRAPHIC SCALE IN FEET

www.mmsconsultants.net

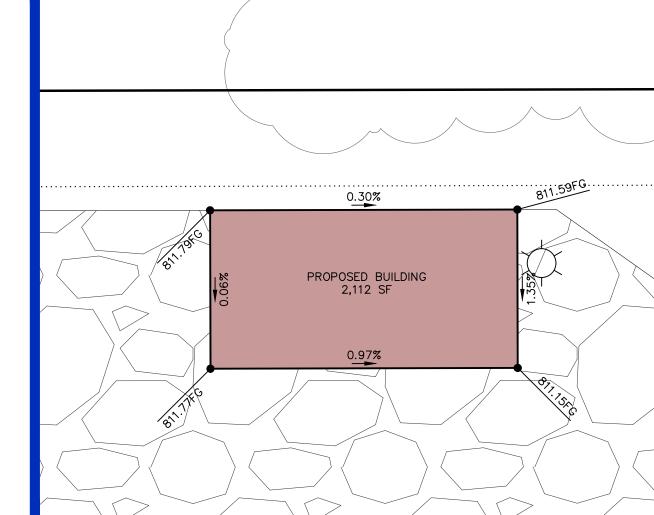


## **DETAILED SITE GRADING PLAN:** NORTH HALF


# 60 SUBDIVISION

JOHNSON COUNTY IOWA

MMS CONSULTANTS, INC. 03-20-2024

Designed by:

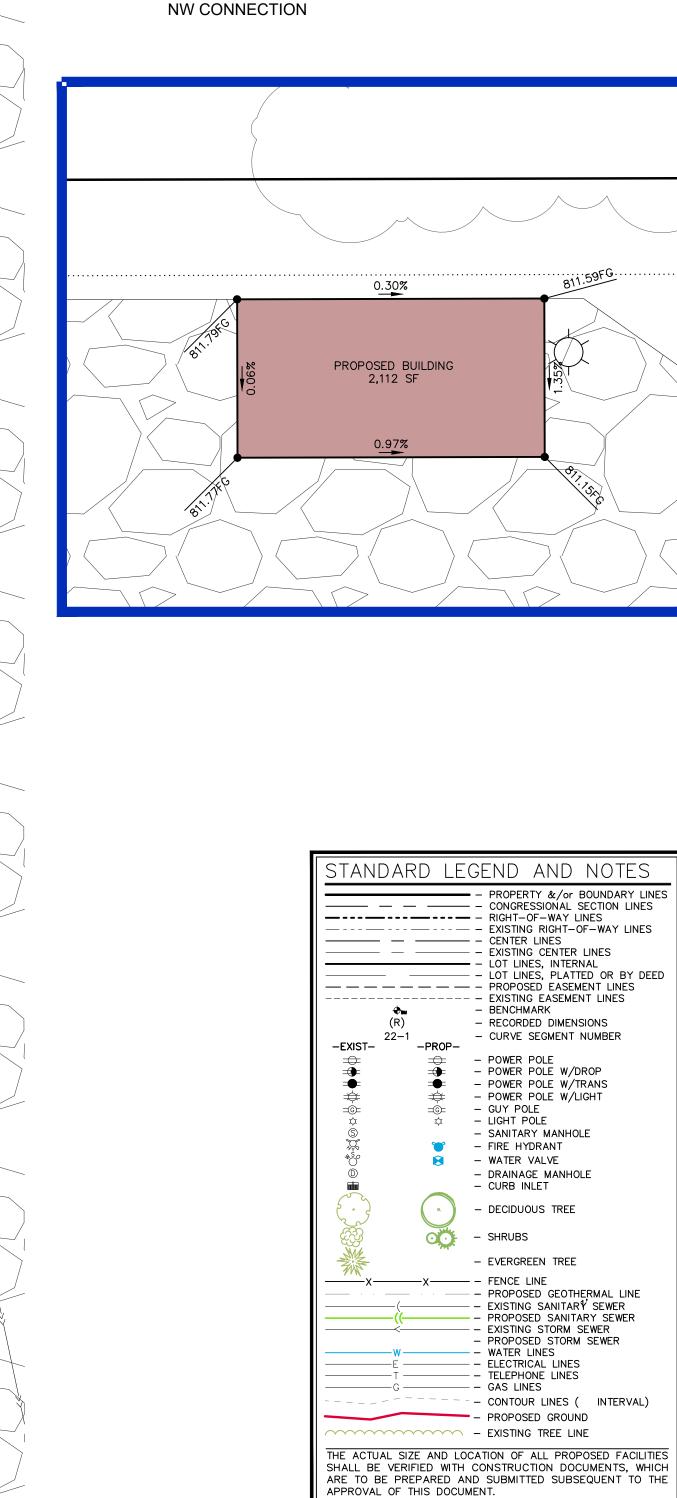

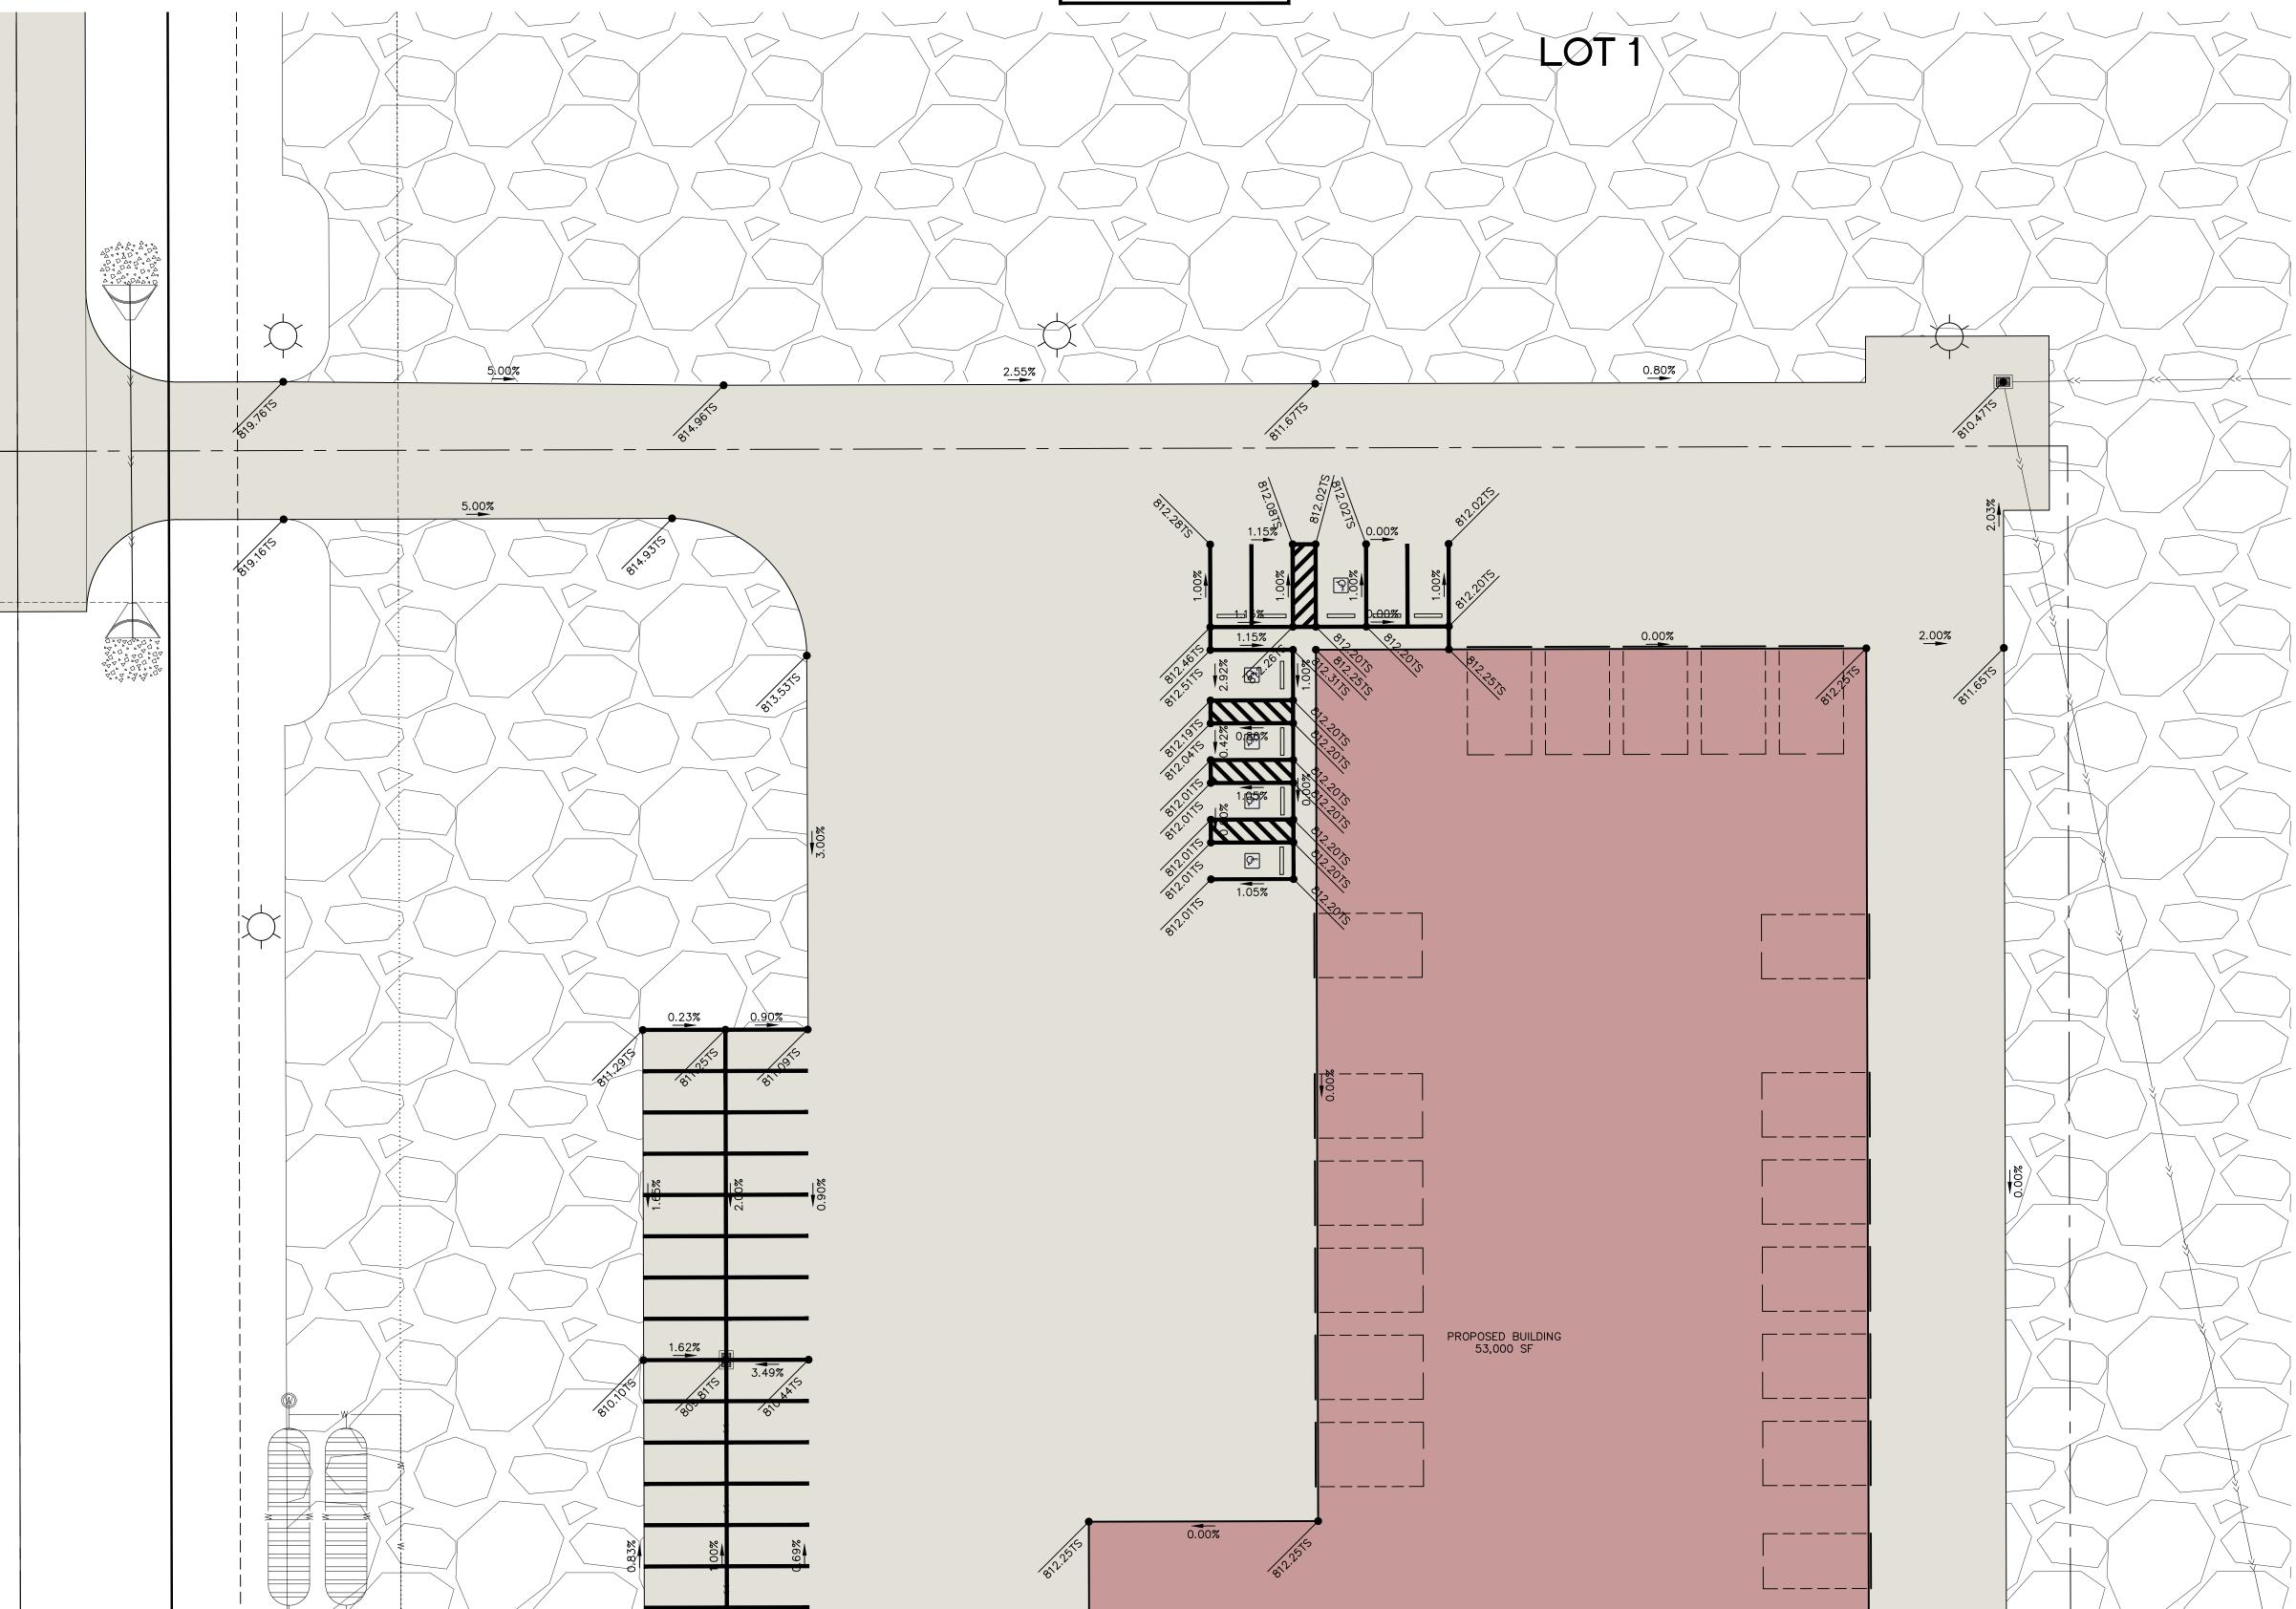



PLAN PREPARED BY: OWN
MMS CONSULTANTS INC. 2612
1917 S. GILBERT STREET 1769
IOWA CITY, IOWA 52240 SOLO

OWNER/APPLICANT: 2612 REC, LLC 1769 HAWTHORN LANE NE SOLON, IOWA 52333

APPLICANT'S ATTORNEY: LESLIE L. MOORE 320 KIRKWOOD AVE IOWA CITY, IOWA 52240

### SHEET INDEX

PROPOSED BUILDING 53,000 SF

\_ \_ \_ \_ \_ \_

3.46%

**₹ ₹** 

SITE LAYOUT & DIMENSION PLAN DETAILED SITE DIMENSION PLAN SITE GRADING PLAN AND SWPPP DETAILED SITE GRADING PLAN: NORTH DETAILED SITE GRADING PLAN: SOUTH C160 SITE UTILITY PLAN C161 SEPTIC DESIGN GENERAL NOTES AND DETAILS SITE LANDSCAPE PLAN PAVING PLAN AND PROFILE: MERRIMENT WAY NW PAVING PLAN AND PROFILE: ANDERSEN AVE NW INTERSECTION DETAIL: HIGHWAY 965 NW & MERRIMENT WAY NW INTERSECTION DETAIL: MERRIMENT

WAY NW & ANDERSEN AVE NW

NW CONNECTION

INTERSECTION DETAIL: ANDERSEN AVE


GRADING LEGEND

O00.00EX = EXISTING SURFACE

O00.00FG = FINISH GRADE

 $\begin{array}{ll} \bullet & 000.00 \text{FG} \\ \hline \bullet & 000.00 \text{TS} \\ \hline \bullet & 000.00 \text{TS} \\ \hline \end{array} = \begin{array}{ll} \text{FINISH GRADE} \\ \hline = & \text{TOP SLAB} \\ \hline \bullet & 000.00 \text{TW} \\ \hline \bullet & 000.00 \text{TC} \\ \hline \end{array} = \begin{array}{ll} \text{TOP WALK} \\ \hline \end{array}$ 

 $\begin{array}{lll}
\bullet_{\overline{000.00WB}} & = \text{ FG AT TOP WALL} \\
\bullet_{\overline{000.00WB}} & = \text{ FG AT BOTTOM WALL}
\end{array}$ 

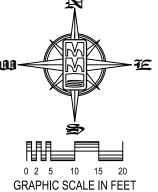


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UTILITIES

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APPROVAL OF THIS DOCUMENT.



LAND PLANNERS

LAND SURVEYORS

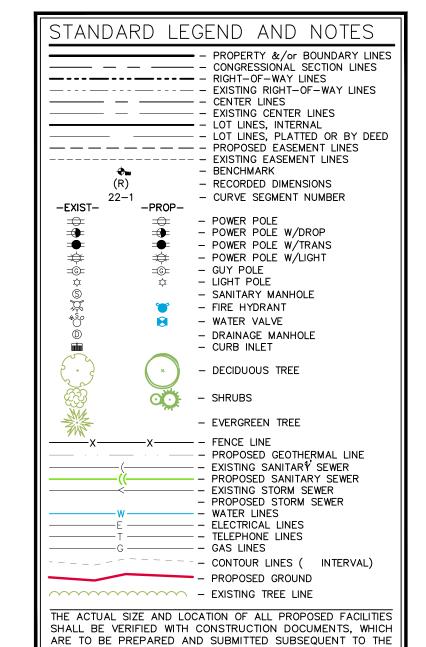LANDSCAPE ARCHITECTS

ENVIRONMENTAL SPECIALISTS

1917 S. GILBERT ST.

IOWA CITY, IOWA 52240
(319) 351-8282

www.mmsconsultants.net

Date Revision

DETAILED SITE GRADING PLAN: SOUTH HALF

LOT 1, SWISHER 60 SUBDIVISION

JOHNSON COUNTY IOWA

MMS CONSULTANTS, INC.

Date:

03-20-2024

Designed by:
CAT/LSS

Drawn by:
ADP
Scale:
1"=20'

CAT Sheet No. C143
301-001 OFF.SHEET

# SITE PLAN LOT 1, SWISHER 60 SUBDIVISION JOHNSON COUNTY, IOWA

<u>PLAN PREPARED BY:</u> MMS CONSULTANTS INC. 1917 S. GILBERT STREET IOWA CITY, IOWA 52240

1769 HAWTHORN LANE NE SOLON, IOWA 52333

APPLICANT'S ATTORNEY: LESLIE L. MOORE 320 KIRKWOOD AVE IOWA CITY, IOWA 52240

STANDARD LEGEND AND NOTES

- — — — — — PROPOSED EASEMENT LINES

— — — EXISTING CENTER LINES

BENCHMARK

GUY POLE LIGHT POLE

- LOT LINES, INTERNAL

— – LOT LINES, PLATTED OR BY DEED

- - EXISTING EASEMENT LINES

 RECORDED DIMENSIONS CURVE SEGMENT NUMBER

- POWER POLE W/DROP

- POWER POLE W/TRANS - POWER POLE W/LIGHT

- SANITARY MANHOLE

- DRAINAGE MANHOLE - CURB INLET - DECIDUOUS TREE

- EVERGREEN TREE

- WATER LINES

GAS LINES

- EXISTING TREE LINE THE ACTUAL SIZE AND LOCATION OF ALL PROPOSED FACILITIES

SHALL BE VERIFIED WITH CONSTRUCTION DOCUMENTS, WHICH

ARE TO BE PREPARED AND SUBMITTED SUBSEQUENT TO THE

- TELEPHONE LINES

- PROPOSED GROUND

— PROPOSED GEOTHERMAL LINE — EXISTING SANITAR∜ SEWER — PROPOSED SANITARY SEWER

- - CONTOUR LINES ( INTERVAL)

- EXISTING STORM SEWER

- PROPOSED STORM SEWER

FIRE HYDRANT

WATER VALVE


SHRUBS

— — — — — CENTER LINES

-PROP-

-EXIST-

- PROPERTY &/or BOUNDARY LINES

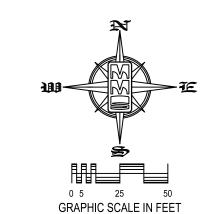

### SHEET INDEX

SITE LAYOUT & DIMENSION PLAN DETAILED SITE DIMENSION PLAN SITE GRADING PLAN AND SWPPP **DETAILED SITE GRADING PLAN: NORTH** 

DETAILED SITE GRADING PLAN: SOUTH SITE UTILITY PLAN

C160 SEPTIC DESIGN

**GENERAL NOTES AND DETAILS** SITE LANDSCAPE PLAN PAVING PLAN AND PROFILE:

MERRIMENT WAY NW PAVING PLAN AND PROFILE: ANDERSEN AVE NW

INTERSECTION DETAIL: HIGHWAY 965 NW & MERRIMENT WAY NW

INTERSECTION DETAIL: MERRIMENT WAY NW & ANDERSEN AVE NW INTERSECTION DETAIL: ANDERSEN AVE

**NW CONNECTION** 

17.26 AC

**CIVIL ENGINEERS** 

LAND PLANNERS

LAND SURVEYORS

LANDSCAPE ARCHITECTS

1917 S. GILBERT ST. IOWA CITY, IOWA 52240

www.mmsconsultants.net

(319) 351-8282

**ENVIRONMENTAL SPECIALISTS** 

SITE UTILITY PLAN

LOT 1, SWISHER 60 SUBDIVISION

JOHNSON COUNTY IOWA

MMS CONSULTANTS, INC.		
Date: 03-20-2024		
Designed by: CAT/LSS	Field Book No:	
Drawn by:	Scale: 1"=50'	

C160

OF:SHEET

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ALLOWED TO THE CONTRACTOR FOR ANY INTERFERENCE OR DELAY CAUSED BY SUCH WORK.

# SEPTIC DESIGN LOT 1, SWISHER 60 SUBDIVISION JOHNSON COUNTY, IOWA

0 2 5 10 15 20 GRAPHIC SCALE IN FEET 1"=20'

PLAN PREPARED BY: MMS CONSULTANTS INC. 1917 S. GILBERT STREET IOWA CITY, IOWA 52240

1769 HAWTHORN LANE NE SOLON, IOWA 52333

APPLICANT'S ATTORNEY
LESLIE D. MOORE 320 KIRKWOOD AVE IOWA CITY, IOWA 52240

C121

C140

C141

C142


C160

C161

CL100

CP101

SHEET INDEX

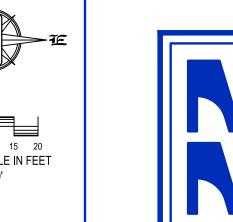

CIVIL ENGINEERS LAND PLANNERS LAND SURVEYORS LANDSCAPE ARCHITECTS 1917 S. GILBERT ST

www.mmsconsultants.net

**ENVIRONMENTAL SPECIALISTS** IOWA CITY, IOWA 52240 (319) 351-8282

ELEVATION DIFFERENCE TO BE COMPLETED BY CONTRACTOR

SITE LAYOUT & DIMENSION PLAN

DETAILED SITE DIMENSION PLAN

SITE GRADING PLAN AND SWPPP

**GENERAL NOTES AND DETAILS** 

SITE UTILITY PLAN

SITE LANDSCAPE PLAN

MERRIMENT WAY NW

ANDERSEN AVE NW

NW CONNECTION

PAVING PLAN AND PROFILE:

PAVING PLAN AND PROFILE:

NW & MERRIMENT WAY NW

SEPTIC DESIGN

DETAILED SITE GRADING PLAN: NORTH

**DETAILED SITE GRADING PLAN: SOUTH** 

**INTERSECTION DETAIL: HIGHWAY 965** 

INTERSECTION DETAIL: MERRIMENT

INTERSECTION DETAIL: ANDERSEN AVE

STANDARD LEGEND AND NOTES

— — — — — — PROPOSED EASEMENT LINES

-PROP-

---- - RIGHT-OF-WAY LINES

- - PROPERTY &/or BOUNDARY LINES —— - CONGRESSIONAL SECTION LINES

- EXISTING RIGHT-OF-WAY LINES

- LOT LINES, PLATTED OR BY DEED

- CENTER LINES

POWER POLE

- LIGHT POLE

WATER VALVE

- CURB INLET

- SHRUBS

- EXISTING CENTER LINES LOT LINES, INTERNAL

- EXISTING EASEMENT LINES

- RECORDED DIMENSIONS

- POWER POLE W/DROP

- POWER POLE W/TRANS

- POWER POLE W/LIGHT

SANITARY MANHOLE FIRE HYDRANT

- DRAINAGE MANHOLE

- DECIDUOUS TREE

- EVERGREEN TREE

- WATER LINES

- PROPOSED GROUND

- GAS LINES

THE ACTUAL SIZE AND LOCATION OF ALL PROPOSED FACILITIES

SHALL BE VERIFIED WITH CONSTRUCTION DOCUMENTS, WHICH

ARE TO BE PREPARED AND SUBMITTED SUBSEQUENT TO THE

APPROVAL OF THIS DOCUMENT.

- ELECTRICAL LINES

- TELEPHONE LINES

- PROPOSED GEOTHERMAL LINE

PROPOSED SANITARY SEWER

- EXISTING SANITAR∜ SEWER

PROPOSED STORM SEWER

- - CONTOUR LINES ( INTERVAL)

CURVE SEGMENT NUMBER

WAY NW & ANDERSEN AVE NW

Fiberglass Gasketed Lid < with Stainless Steel Bolts - PVC Riser with Grommet(s)

Gravity flow from Septic \_\_\_\_ tank to dosing tank DOSING SIPHON SYSTEM -4" DIAMETER

-EXIST-

SEPTIC DESIGN

# LOT 1, SWISHER 60 SUBDIVISION

JOHNSON COUNTY

MMS CONSULTANTS, INC.


03-20-2024 Field Book No: CAT/LSS Project No: OF:SHEET

# TABLE 1: PRESSURE DISTRIBUTION FOR SAND FILTER SYSTEM

Number of Employees/day Flow rate per Employee (GPD) Sizing Rate Total Flow Rate (GPD) 1,080 Area of Sand Filter (sf) 1,080 Siphon Dose <u>Pressure Distribution Values</u> Bed Width (ft) Bed Length (ft) Lateral Length (ft) Lateral Diameter (in) No. of Laterals Hole Spacing (ft) No. of Holes/lateral Hole Diameter (in) Discharge Rate (gpm/hole) 0.71 Lateral Discharge (gpm/lateral) 21.3 Manifold Length (ft) Manifold Diameter (in) Supply Line Length (ft) Supply Line Diameter Volume of Distribution System (gal) Volume of Distribution System and Supply Line (gal) No. of Siphons (ea) Discharge Rate per pump (gpm) 85.2 1080 Flow per Siphon/day Min. Dosing/day/bed (doses/day) Dosing Vol. to sand filter (gal/dose) 108 Min Drop from Siphon Outlet to Sand Filter (ft)

Septic Tank
Minimum Primary Septic Tank Required Dosing Tank

2500 gallons 500 gallons

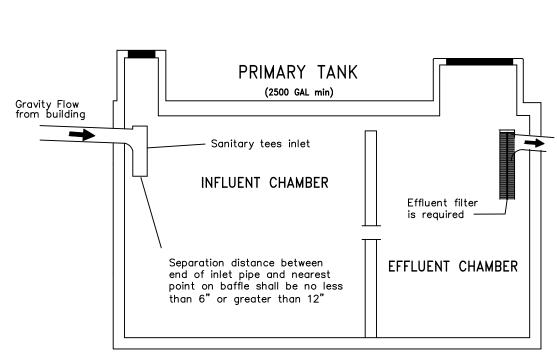

PRIMARY SEPTIC TANK

EXISTING SOIL


SAND FILTER SHALL BE PLACED ON A CONVEX

SLOPE AND THE SURFACE WATER SHALL BE

DIVERTED AWAY FROM THE SYSTEM.

LOCATION AND TO AVOID DAMAGE THERETO. NO CLAIMS FOR ADDITIONAL COMPENSATION WILL BE

ALLOWED TO THE CONTRACTOR FOR ANY INTERFERENCE OR DELAY CAUSED BY SUCH WORK.

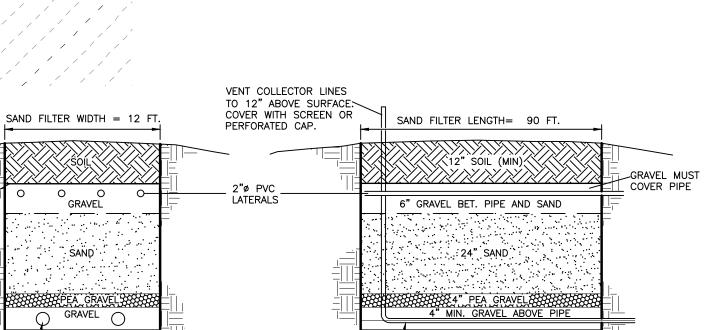

4"ø COLLECTOR LINE

SAND FILTER CROSS SECTIONS

## Manifold Pipe ENGINEERING FILTER FABRIC 2" Perforated Lateral 4" Supply Pipe (Perforations on Bottom of `From Dosing Chamber Plastic Pipe) Lateral cleanouts EXISTING SOIL 4"ø COLLECTOR LINE (See detail) LAYOUT OF PERFORATED PIPE LATERALS FOR PRESSURE

OUBLE CLEANOUT REQUIRED.

-CLEANOUT REQUIRED FOR

EVERY 100' OF SEWER LINE.

-POSSIBLE LOCATION OF NEW

SEPTIC TANK. TANK MUST HAVE 2 CHAMBERS WITH A MINIMUM

2500 GALLON LIQUID HOLDING

\_CAPACITY AND AN EFFLUENT

-DOSING SIPHON REQUIRED.

DOSING CHAMBER SHALL HAVE A

MINIMUM 500 GALLON CAPACITY.

DISTRIBUTION IN SAND FILTER

Perforation Length

THREADED -2" LATERAL

MINIMUM 10" DIA PVC OR HDPE ──RISER EXTENDS ½" INSIDE RISER WALL

SAMPLING PORT DETAIL (as needed)

THE CONTRACTOR SHALL NOTIFY IOWA ONE CALL AT 811 OR 800/292-8989 NO LESS THAN 48 HRS. IN ADVANCE OF ANY DIGGING OR EXCAVATION. WHERE PUBLIC UTILITY FIXTURES ARE SHOWN AS EXISTING ON THE PLANS OR ENCOUNTERED WITHIN THE CONSTRUCTION AREA, IT SHALL BE THE RESPONSIBILITY OF THE CONTRACTOR TO NOTIFY THE OWNERS OF THOSE UTILITIES PRIOR TO THE BEGINNING OF ANY CONSTRUCTION. THE CONTRACTOR SHALL AFFORD ACCESS TO THESE FACILITIES FOR NECESSARY MODIFICATION OF SERVICES. UNDERGROUND FACILITIES, STRUCTURES AND UTILITIES HAVE BEEN PLOTTED FROM AVAILABLE SURVEYS AND RECORDS, AND THEREFORE THEIR LOCATIONS MUST BE CONSIDERED APPROXIMATE ONLY. IT IS POSSIBLE THERE MAY BE OTHERS, THE EXISTENCE OF WHICH IS PRESENTLY NOT KNOWN OR SHOWN, IT IS THE CONTRACTOR'S RESPONSIBILITY TO DETERMINE THEIR EXISTENCE AND EXACT

PERFORATED PVC PIPE 3/16" Perforations Size PERFORATED PIPE DETAIL

10' SETBACK

12' X 90' SAND FILTER -

SAMPLING PORT

TO BE SURFACE

DOWNSLOPE OF

-DISCHARGED

6" RISER BOX W/COVER RAIN BIRD VB-6RND OR QUANICS PDS-AVB CONNECTION 90 DEG. CONDUIT SWEEP ELBOW LATERAL CLEANOUT DETAIL

NOTÉ: SÉPTIC TANK MÚST MAINTAIN

A MINIMUM 50' SETBACK DISTANCE

FROM WELL HEAD AND THE SAND

FILTER MUST MAINTAIN A MINIMUM

100' SETBACK DISTANCE FROM THE

JAR TEST FOR CLEAN SAND PLACE 2 INCHES SAND IN MASON JAR, ADD WATER AND SHAKE VIGOROUSLY.
IF THE FINES THAT SETTLE
OUT IN 1 HOUR ARE GREATER THAN 1/8 INCH THEN THE PERCENTAGE OF THEN THE PERCENTAGE OF FINES IS TOO GREAT AND THE SAND SHOULD NOT BE USED FOR SAND FILTER CONSTRUCTION.

SYSTEM SHALL BE CONSTRUCTED IN ACCORDANCE WITH JOHNSON COUNTY PUBLIC HEALTH, "PRIVATE SEWAGE DISPOSAL

. MMS CONSULTANTS, INC. SHALL NOT BE RESPONSIBLE FOR THE CONTRACTOR'S MEANS, METHODS OR MATERIALS.

4. SYSTEM MUST BE INSTALLED ACCORDING TO THE MINIMUM STANDARDS IN TABLE 1 ABOVE. ANY DESIGN MODIFICATIONS

MUST BE SUBMITTED TO THE HEALTH DEPARTMENT DURING THE FINAL INSPECTION. FAILURE TO DO SO SHALL MAKE

5. A SHARP DRILL BIT SHALL BE USED TO DRILL THE LATERAL PERFORATIONS. REMOVE ALL BURRS AND FILLINGS FROM

B. PROVIDE WATERTIGHT RISERS AS NECESSARY TO EXTEND ACCESS TO THE GROUND SURFACE AS SHOWN ON EACH

. CLEANING ACCESS OPENING SHALL BE SECURED BY USING STAINLESS STEEL FASTENERS OF SUFFICIENT COMPLEXITY,

10. SEPTIC TANK EFFLUENT FILTER REQUIRED TO HELP PROTECT DISTRIBUTION PIPING AND DRAINFIELD FROM HIGH SOLIDS

. THE VERTICAL ELEVATION SEPARATION BETWEEN THE OUTLET OF THE DOSING SIPHON AND THE DISTRIBUTION MANIFOLD

SHALL ADHERE TO MANUFACTURER'S SPECIFICATION, AND ELEVATION PROVIDED IN TABLE ONE, BUT IN NO CASE BE

LOCKING DEVICES, CONCRETE LIDS OF SUFFICIENT WEIGHT OR ANOTHER APPROVED DEVICE TO DETER TAMPERING.

PIPE BEFORE ASSEMBLY. REPLACE DRILL BITS OFTEN. SHOP DRILLED PERFORATIONS ARE PREFERRED.

. PRIMARY TANK SHALL BE FOLLOWED IN SERIES BY A DOSING TANK WITH A MINIMUM 500 GAL CAPACITY.

6. PRIMARY SEPTIC TANK SHALL HAVE TWO CHAMBERS WITH A 2500 GAL. MINIMUM HOLDING CAPACITY.

SYSTEM REGULATIONS-2020", AND CHAPTER 69 OF THE IOWA ADMINISTRATIVE CODE.


3. DO NOT ALLOW ANYONE TO DRIVE OR PARK OVER ANY PART OF SYSTEM.

BUILD UP. USE BIOMICROBICS SANITEE OR EQUIVALENT.

CONTRACTOR SHALL FIELD LOCATE ALL UTILITIES INCLUDING PRIVATE

UTILITIES BEFORE INSTALLING SYSTEM.

SEPTIC NOTES:

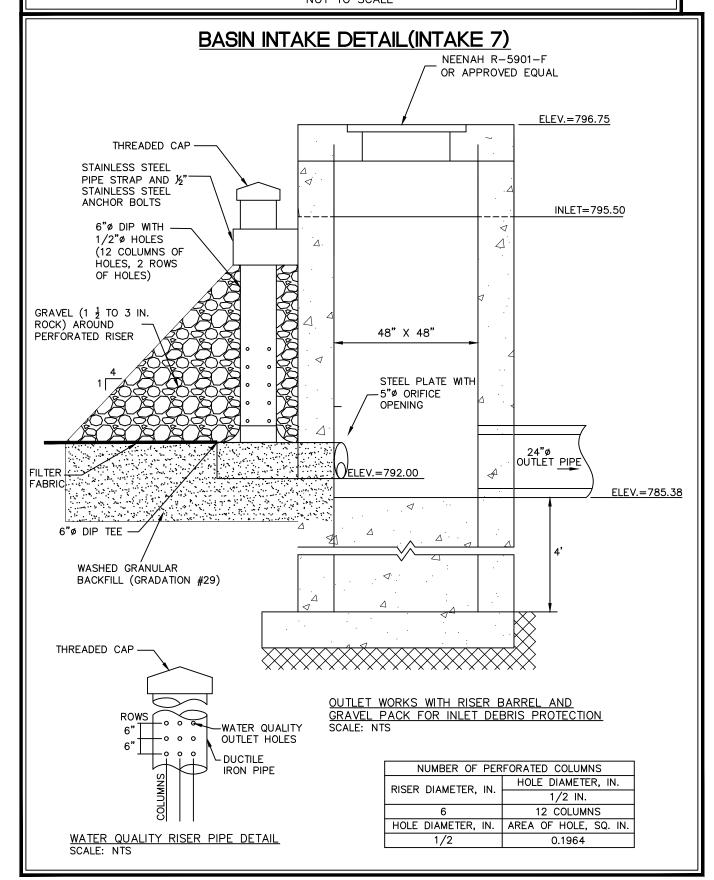



## STORM SEWER CONSTRUCTION NOTES

- 1) ALL STORM SEWER AND SUB-SURFACE CONSTRUCTION SHALL CONFORM TO PLANS AND DETAILS PREPARED FOR THIS PROJECT BY MMS CONSULTANTS, INC., AS WELL AS CONFORM TO THE IOWA STATEWIDE URBAN DESIGN AND SPECIFICATIONS (SUDAS) MANUAL. CONSTRUCTION SHALL ALSO CONFORM TO THE CURRENT JOHNSON COUNTY DESIGN STANDARDS, WHICH SHALL SUPERSEDE PLANS AND DETAILS PROVIDED BY MMS CONSULTANTS.
- 2) ALL STORM SEWER INTAKE AND MANHOLE LIDS SHALL HAVE THE WORDS "STORM SEWER" CAST INTO THE LID.
- 3) ALL REINFORCED CONCRETE PIPE (RCP) SHALL CONFORM TO SUDAS SPECIFICATION 4020, WITH THE FOLLOWING ADDITIONAL RESTRICTIONS: ALL RCP JOINTS FOR 36" AND SMALLER PIPE SHALL HAVE TONGUE AND GROOVE JOINTS INCORPORATING RUBBER "O"-RING OR PROFILE GASKETS COMPLYING WITH ASTM C443.
- 4) RCP PIPE BEDDING SHALL CONFORM TO SUDAS FIGURE 3010.102 CLASS R-1. CLASS 1 BEDDING MATERIAL SHALL BE AS SPECIFIED IN SUDAS SPECIFICATION 3010,2.02. TRENCH BACKFILL SHALL BE SUITABLE EXCAVATED MATERIAL AS IDENTIFIED IN SUDAS SPECIFICATION 3010,2.01, PLACED AND COMPACTED IN ACCORDANCE WITH SECTIONS 3.05, D AND E. THE OWNER MAY ELECT TO TEST TRENCH COMPACTION AT THEIR OWN EXPENSE.
- 5) SUB-SURFACE DRAINAGE PIPE SHALL BE HIGH DENSITY POLYETHYLENE PIPE (HDPE) CONFORMING TO SUDAS SPECIFICATION 4040 FOR BOTH PERFORATED TILE AND SOLID WALL PIPE.
- 6) FOR SUB-SURFACE DRAINAGE IN TURF AREAS HDPE PIPE BEDDING SHALL CONFORM TO SUDAS FIGURE 3010.103 CLASS F-3. BEDDING MATERIAL SHALL BE POROUS BACKFILL MATERIAL AS SPECIFIED IN SUDAS SPECIFICAITION 4040,2.04. TRENCH BACKFILL SHALL BE SUITABLE EXCAVATED MATERIAL AS IDENTIFIED IN SUDAS SPECIFICATION 3010,2.01 PLACED AND COMPACTED IN
- 7) AT LOCATIONS WHERE A FLARED END SECTION IS REQUIRED, THE PIPE LENGTHS SHALL BE MEASURED TO THE END OF THE FLARED END. THE FLARED END SECTION AND THE TWO UPSTREAM JOINTS ARE TO INCORPORATE TIED JOINTS.
- 8) ALL FIELD TILE ENCOUNTERED DURING CONSTRUCTION SHALL BE CONNECTED TO THE PROPOSED STORM SEWER.

ACCORDANCE WITH SECTIONS 3.05 D AND E.

NOTIFY ENGINEER OF ALL FIELD TILES ENCOUNTERED. 9) CONTRACTOR SHALL PROVIDE A FIVE-YEAR MAINTENANCE BOND COVERING DEFECTIVE MATERIALS AND WORKMANSHIP FOR ALL STORM SEWER SYSTEM IMPROVEMENTS.

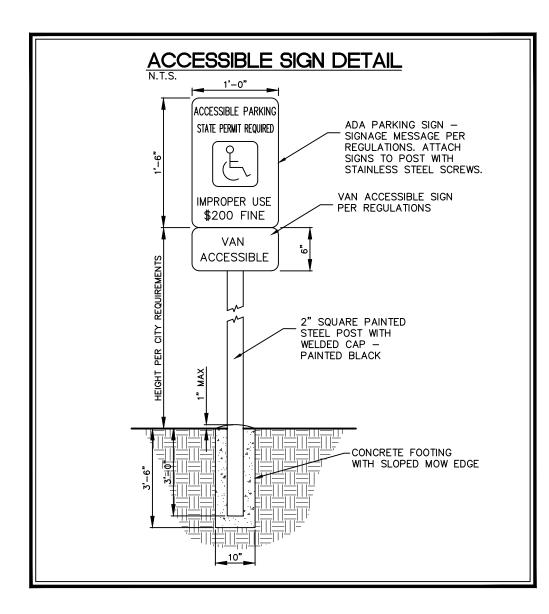

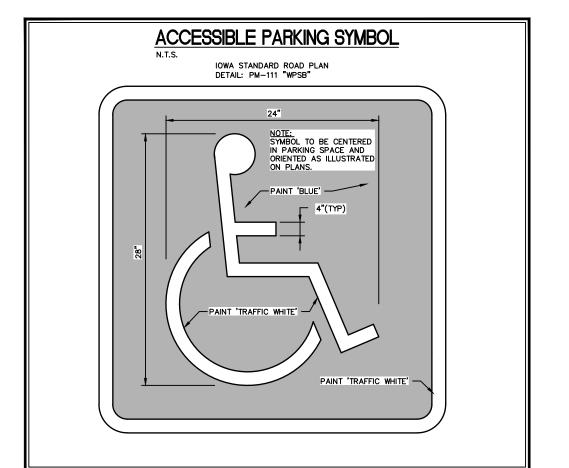

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> NW & MERRIMENT WAY NW INTERSECTION DETAIL: MERRIMENT WAY NW & ANDERSEN AVE NW INTERSECTION DETAIL: ANDERSEN AVE

NW CONNECTION

Date Revision

17.26 AC

**CIVIL ENGINEERS** 

LAND PLANNERS

LAND SURVEYORS

1917 S. GILBERT ST.


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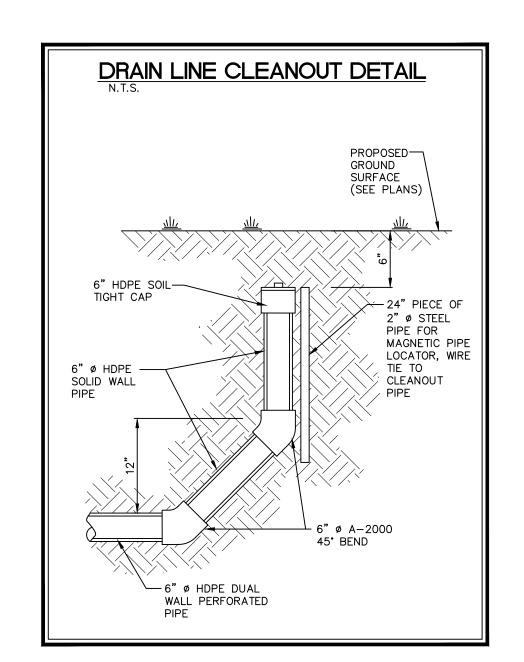
IOWA CITY, IOWA 52240


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LANDSCAPE ARCHITECTS

ENVIRONMENTAL SPECIALISTS





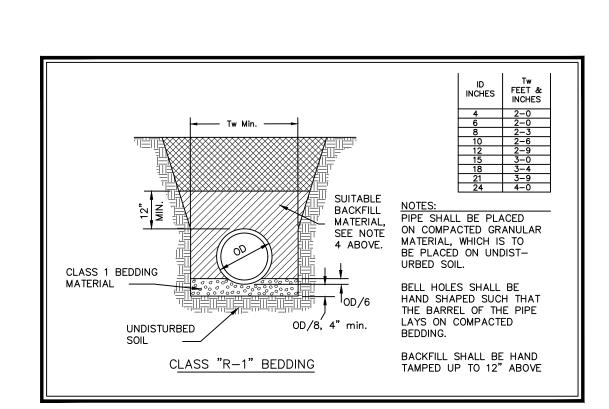
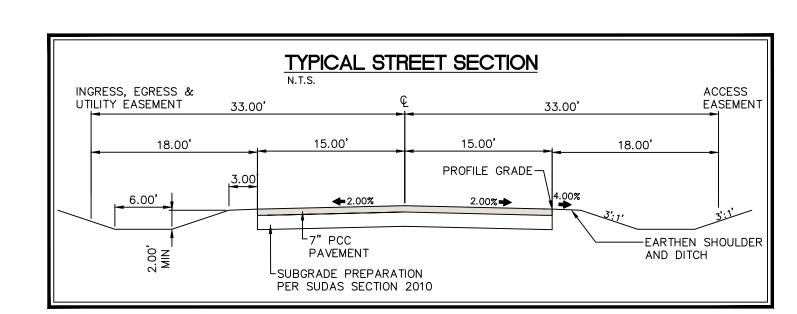
## GENERAL NOTES AND DETAILS

## LOT 1, SWISHER 60 SUBDIVISION

JOHNSON COUNTY IOWA

MMS CONSULTANTS, INC. 03-20-2024 Designed by: Field Book No: Drawn by: Checked by:

OF:SHEET

Project No:

LAND PLANNERS LAND SURVEYORS

1917 S. GILBERT ST. IOWA CITY, IOWA 52240

(319) 351-8282

LANDSCAPE ARCHITECTS

www.mmsconsultants.net

**ENVIRONMENTAL SPECIALISTS** 

## LANDSCAPE NOTES:

### - THE LANDSCAPE CONTRACTOR SHALL VERIFY ALL LOCATIONS OF UNDERGROUND UTILITIES ON SITE PRIOR TO LANDSCAPE INSTALLATION.

- PLANT QUANTITIES ARE FOR INFORMATION ONLY; DRAWING SHALL PREVAIL IF CONFLICT OCCURS.

- KIND, SIZE AND QUALITY OF PLANT MATERIAL SHALL CONFORM TO AMERICAN STANDARD FOR NURSERY STOCK, ANSI Z60 1990, OR MOST RECENT ADDITION. - LAYOUT OF PLANT MATERIAL AT SITE SHALL BE APPROVED BY THE LANDSCAPE ARCHITECT PRIOR TO INSTALLATION.
- ALL PLANTING BED AREAS SHALL HAVE QUALITY TOPSOIL ADDED (IF NEEDED) BY LANDSCAPE CONTRACTOR TO BRING BED GRADES 3" 4" BELOW EXISTING CONCRETE AREAS AND TOP OF DECORATIVE WALLS. (PRIOR TO BIDDING, CONTRACTOR IS RECOMMENDED TO VISIT SITE)
- ALL SHRUB AND PERENNIAL PLANTING AREAS SHALL HAVE A MINIMUM 3 INCH DEEP BED OF DOUBLE SHREDDED HARDWOOD BARK MULCH AND AN APPLICATION OF A PRE-EMERGENT ("PREEN" OR APPROVED EQUAL) FOR WEED CONTROL.
- LANDSCAPE EDGING BETWEEN BARK MULCH AND LAWN AREAS SHALL BE A SPADE CUT EDGE. EDGE SHALL BE INSTALLED VERTICAL AND ACCORDING TO DETAILS - STAKING SHALL DE REQUIRED ON ALL TREES (EXCEPT MULTI-STEM VARIETIES) STAKE USING (2) OR (3) & STEEL "T" POST PLACED OUTSIDE OF ROOTBALL AND ADHERED TO TRUNK OF TREE WITH 16 GAUGE CAPLE AND WOVEN NYLON TREE STRAPS.
- ? ALL TREES FREE-STANDING IN LAWN AREAS AND IN PLANTING BEDS. SHALL BE WRAPPED WITH A STANDARD MANUFACTURED TREE WRAP AND FASTENED WITH TWINE OR APPROVED METHOD. - ALL TREES FREE-STANDING WITHIN LAWN AREAS SHALL HAVE A MINIMUM 4 FT. DIA. RING OF DOUBLE SHREDDED HARDWOOD BARK MULCH AT A 3 INCH DEPTH.
- ALL LANDSCAPE PLANTINGS AND SOD AREAS SHALL BE THOROUGHLY WATERED UPON INSTALLATION AND A TOTAL OF (3) WATERINGS BEFORE INITIAL ACCEPTANCE.

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INTERSECTION DETAIL: MERRIMENT

INTERSECTION DETAIL: ANDERSEN AVE

WAY NW & ANDERSEN AVE NW

- LANDSCAPE CONTRACTOR MUST FOLLOW ALL DETAILS PROVIDED ON SHEETS DESCRIBING LANDSCAPE CONSTRUCTION TECHNIQUES.
- 4 ALL LANDSCAPE PLANTINGS SHALL BE GUARANTEED FØR A PERIØD ØF ØNE YEAR FRØM DATE ØF INITIAL ACCEPTANCE.

5 — SEED ALL REMAINING AREAS WITH IDOT URBAN MIX.


# SITE PLAN LOT 1, SWISHER 60 SUBDIVISION JOHNSON COUNTY, IOWA

PLAN PREPARED BY:
MMS CONSULTANTS INC. 1917 S. GILBERT STREET

IOWA CITY, IOWA 52240

2612 REC, LLC 1769 HAWTHORN LANE NE SOLON, IOWA 52333

LESLIE L. MOORE 320 KIRKWOOD AVE IOWA CITY, IOWA 52240

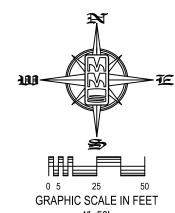

—CABLE

STAKING ORIENTATION PLAN

-PLANT WITH BASE OF TREE A

MIN. 1" ABOVE ADJACENT GRADE

ENSURE ROOT FLARE IS VIABLE

- REMOVE ALL TWINE AND STRAPS OR CUT AND FOLD WIRE BASKET

-3" MINIMUM DEPTH SHREDDED

ROOT FLARE IS VIABLE

AND CUT BURLAP FROM TOP 1/2

HARDWOOD BARK MULCH, ENSURE

3" WATER RETENTION SOIL RING

- EXISTING UNDISTURBED SUBGRADE

- PLANTING MIX/NATIVE SOIL BACKFILL

2.5 X ROOT BALL DIAMETER

INCREASE PIT DIAMETER IN HEAVY CLAY SOILS

SLANT AND ROUGHEN SIDES;

SIDEWALK/PAVING

LANDSCAPE REQUIREMENTS

WHERE OUTDOOR DISPLAY OF GOODS FOR SALE OR VISIBILITY OF THE BUSINESS TO THE TRAVELING PUBLIC ARE INTEGRAL TO THE USE, AT THE DISCRETION OF THE APPROVING AUTHORITY THE OVERSTORY REQUIREMENTS OF THIS SECTION MAY BE REDUCED OR WAIVED AND THE DENSITY REQUIREMENTS FOR UNDERSTORY MAY BE REDUCED BY 50% FOR AREAS THAT FRONT A PUBLIC OR

VEGETATIVE OVERSTORY: 1 TREE EVERY 50' OF FRONTAGE. - 888 LF / 50 = 18 TREES REQUIRED -- 9 TREES PROVIDED (50% OF REQUIRED)

VEGETATIVE UNDERSTORY: 66% SCREENING AT A HEIGHT OF 3' ABOVE GRADE. - 888 LF X 0.66 = 586.08 / 5 = 117 SHRUBS

-- 60 SHRUBS PROVIDED (51% OF REQUIRED)

### PLANT SCHEDULE

PRUNE BROKEN BRANCHES

AS NECESSARY, MAX. 1/3

NARROW BRANCH UNION ANGLE WITH EVIDENCE OF

INCLUDED BARK AND/OR

BRANCH/TRUNK DIAMETER RATIO GREATER THAN 3/3

STRAPS, SIZE TO ALLOW

GALVANIZED AIRCRAFT-GRADE 16 GAUGE CABLES, ONLY TIGHT

ENOUGH TO PREVENT SLIPPING;

ALLOW SOME TREE MOVEMENT

2' - 6" STEEL "T" POST, -

ORIENTATION PLAN, REMOVE

AFTER TWO GROWING SEASONS

STAKE PER STAKING

EDGE OF MULCH AREA

5" DEEP VERTICAL —

FERTILIZER TABLETS (3)

AROUND ROOTBALL

PER TREE SPACED EVENLY

SPADE CUT EDGE STRIP SOD FROM UNDER-

MULCHED AREA

MIN. 3' RADIUS

1.5"ø OF TRUNK GROWTH, PLACE AT % HEIGHT OF FIRST BRANCHING

SHALL BE REJECTED. —

WOVEN NYLON TREE

SYMBOL	CODE	QTY	BOTANICAL NAME	COMMON NAME	INSTALL SIZE
TREES					
	GI	3	Gleditsia triacanthos inermis 'Skycole'	Skyline® Honey Locust	2" Cal.
	GK	I	Gymnocladus dioicus	Kentucky Coffeetree	2" Cal.
	QA	1	Quercus alba	White Oak	2" Cal.
$\odot$	QB	1	Quercus bicolor	Swamp White Oak	2" Cal.
	QR	1	Quercus rubra	Northern Red Oak	2" Cal.
	TB	1	Tilia americana 'Bailyard'	Frontyard® American Linden	2" Cal.
0	UP	I	Ulmus x 'Morton Glossy'	Triumph™ Elm	2" Cal.
SHRUBS ③	CF PP	30 30	Cornus sericea 'Farrow' Panicum virgatum 'Praine Fire'	Arctic Fire® Red Twig Dogwood Prairie Fire Switch Grass	5" Ht.   5" Ht.

TYPICAL TREE PLANTING DETAIL

# LANDSCAPE PLAN

LOT 1, SWISHER 60 SUBDIVISION

JOHNSON COUNTY

MMS CONSULTANTS, INC.

Designed by:

Drawn by:


Checked by:

Project No:

03-20-2024

OF:SHEET


Field Book No:

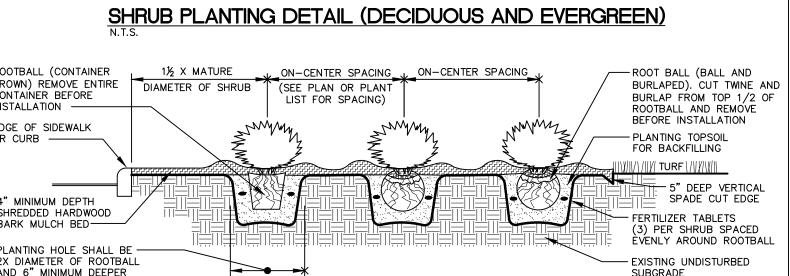


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ROOTBALL (CONTAINER GROWN) REMOVE ENTIRE CONTAINER BEFORE EDGE OF SIDEWALK OR CURB — 4" MINIMUM DEPTH SHREDDED HARDWOOD BARK MULCH BED 2X DIAMETER OF ROOTBALL AND 6" MINIMUM DEEPER



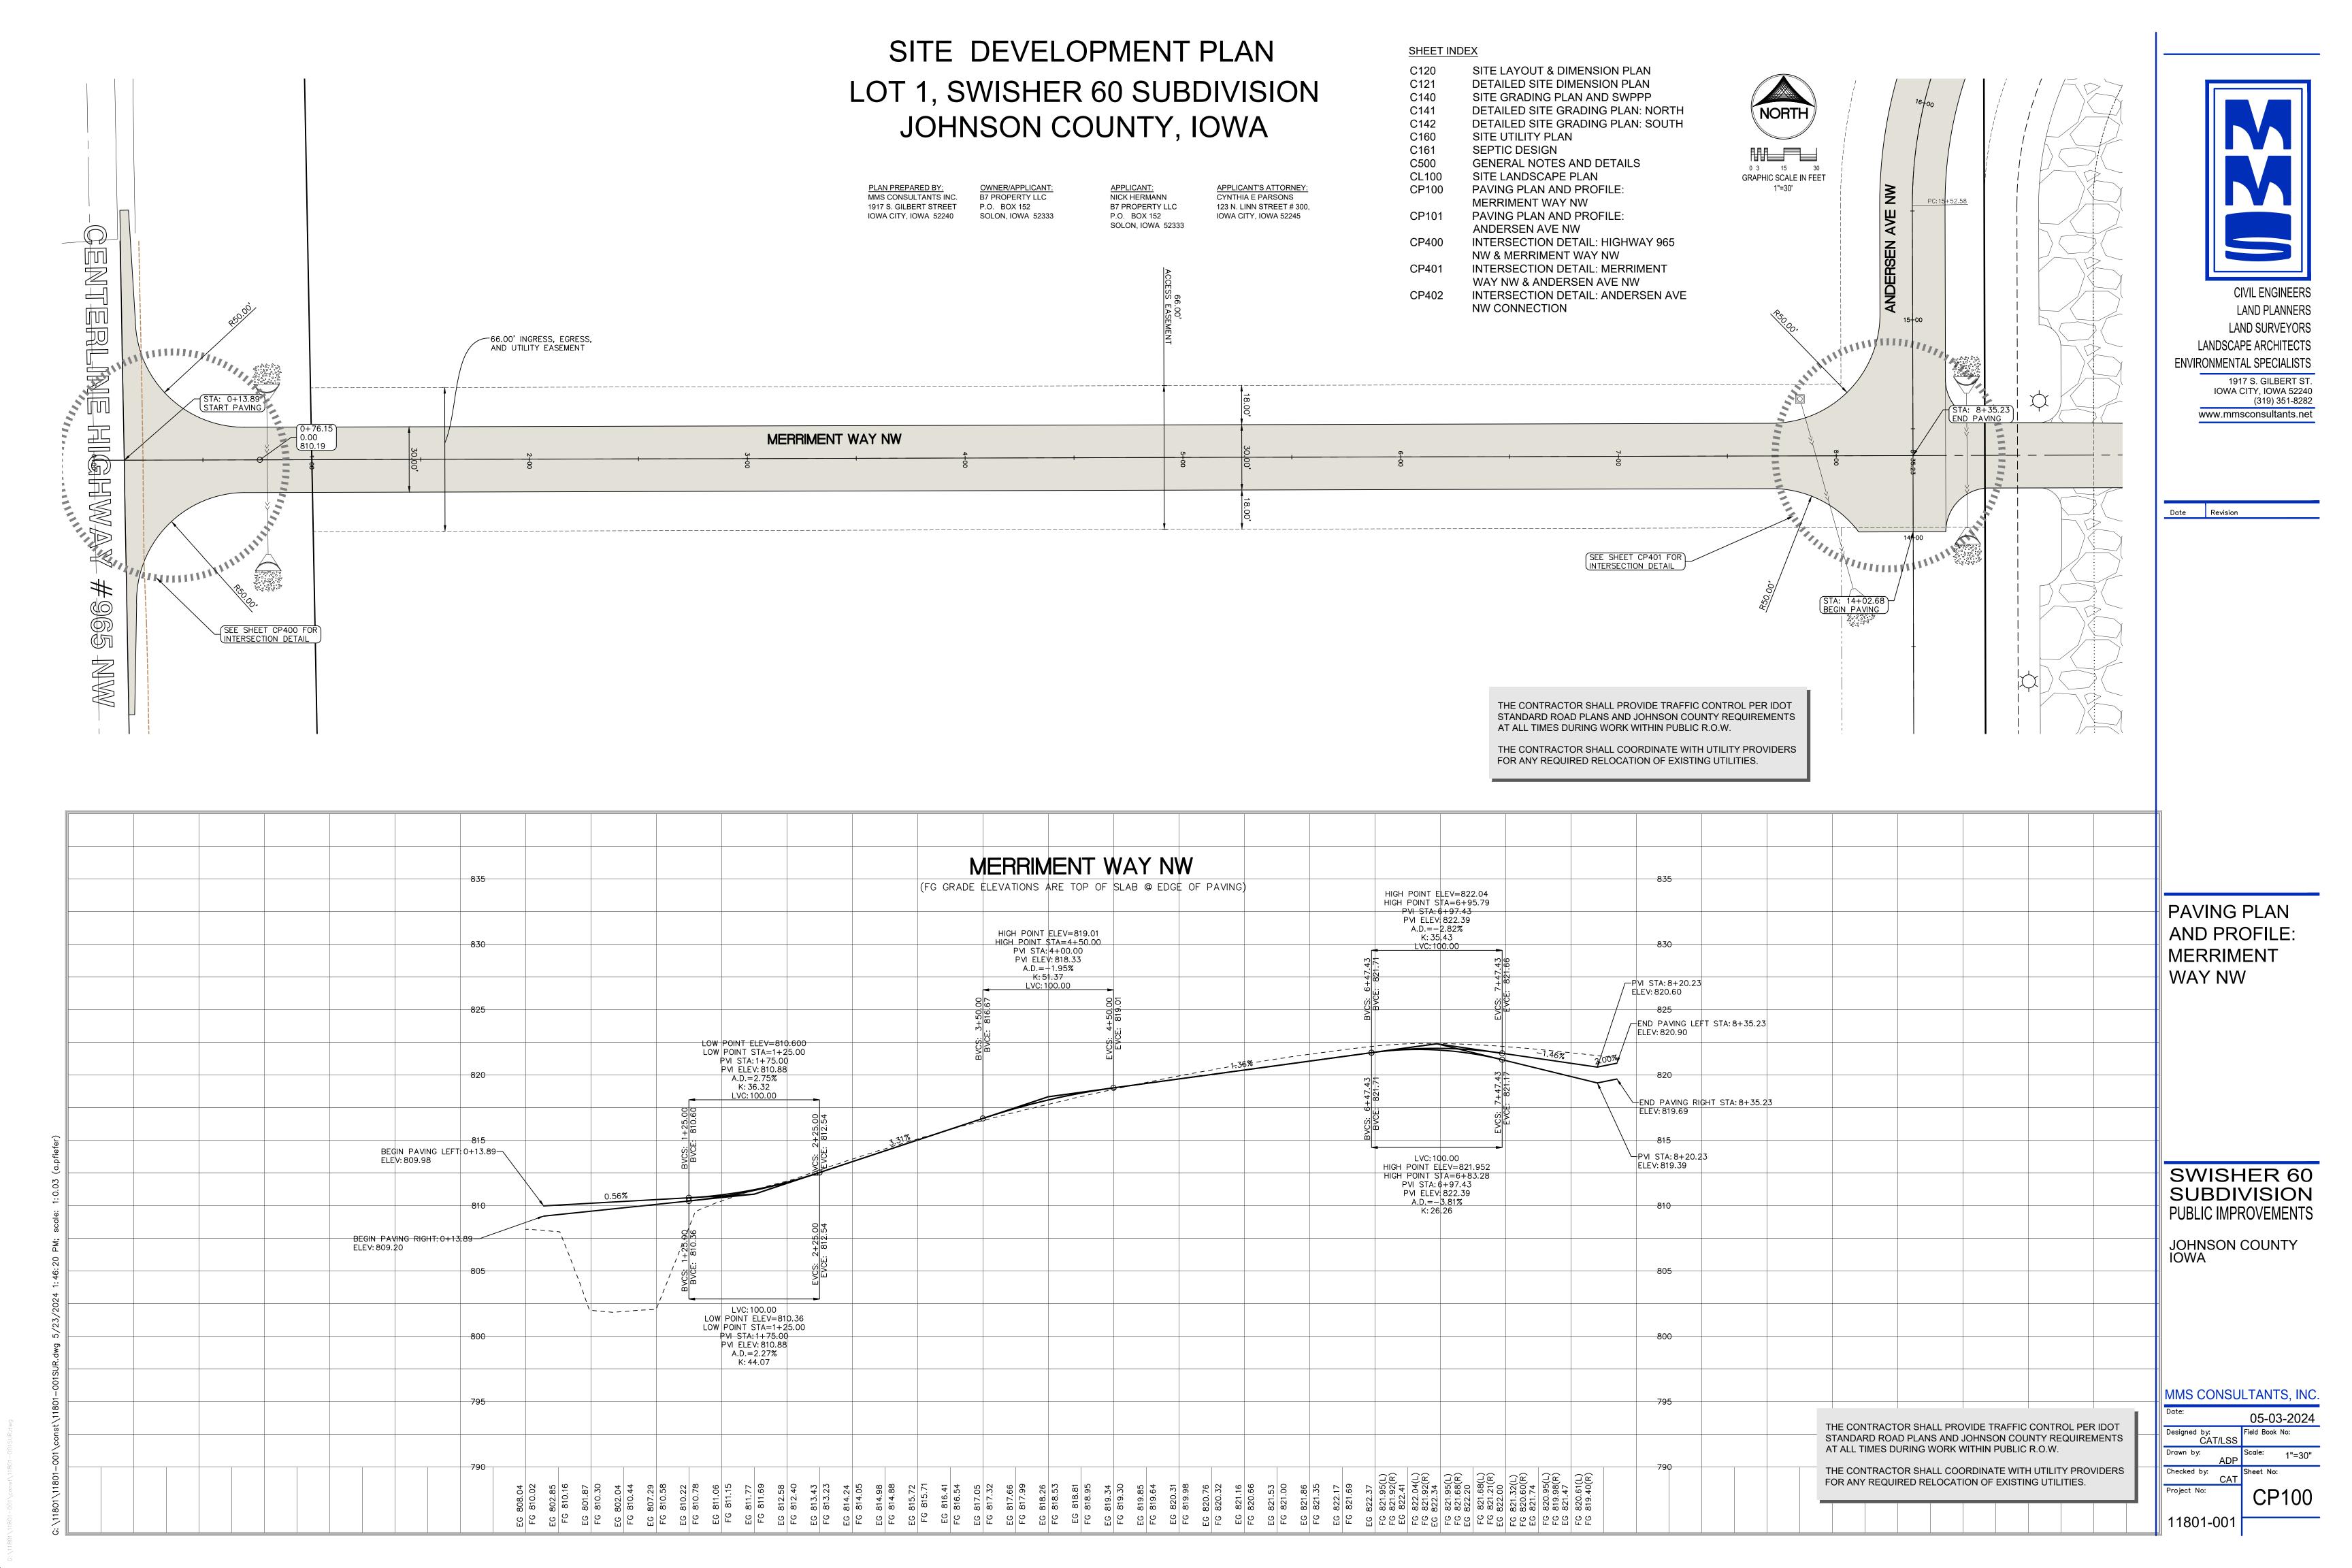

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STA: 17+85.66 END PAVING

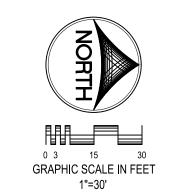
SEE SHEET CP402 FOR INTERSECTION DETAIL


ANDERSEN AVE NW

THE CONTRACTOR SHALL PROVIDE TRAFFIC CONTROL PER IDOT STANDARD ROAD PLANS AND JOHNSON COUNTY REQUIREMENTS AT ALL TIMES DURING WORK WITHIN PUBLIC R.O.W.

F----E

THE CONTRACTOR SHALL COORDINATE WITH UTILITY PROVIDERS FOR ANY REQUIRED RELOCATION OF EXISTING UTILITIES.

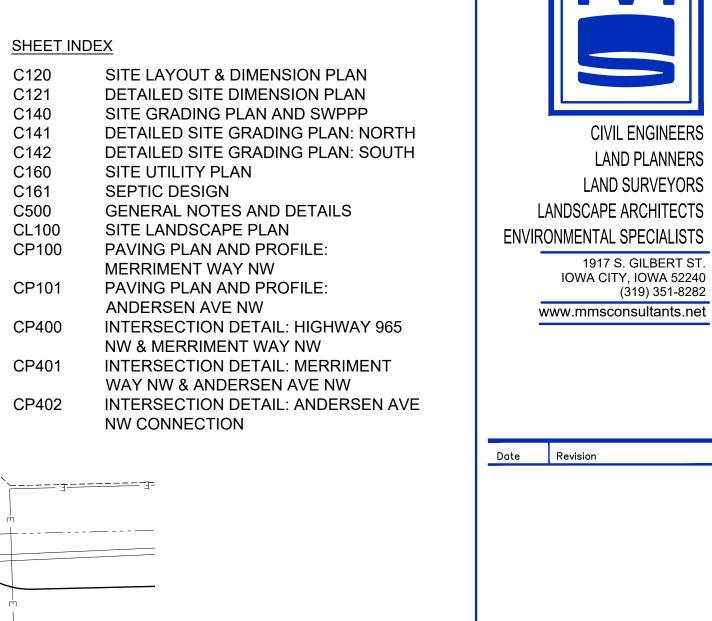

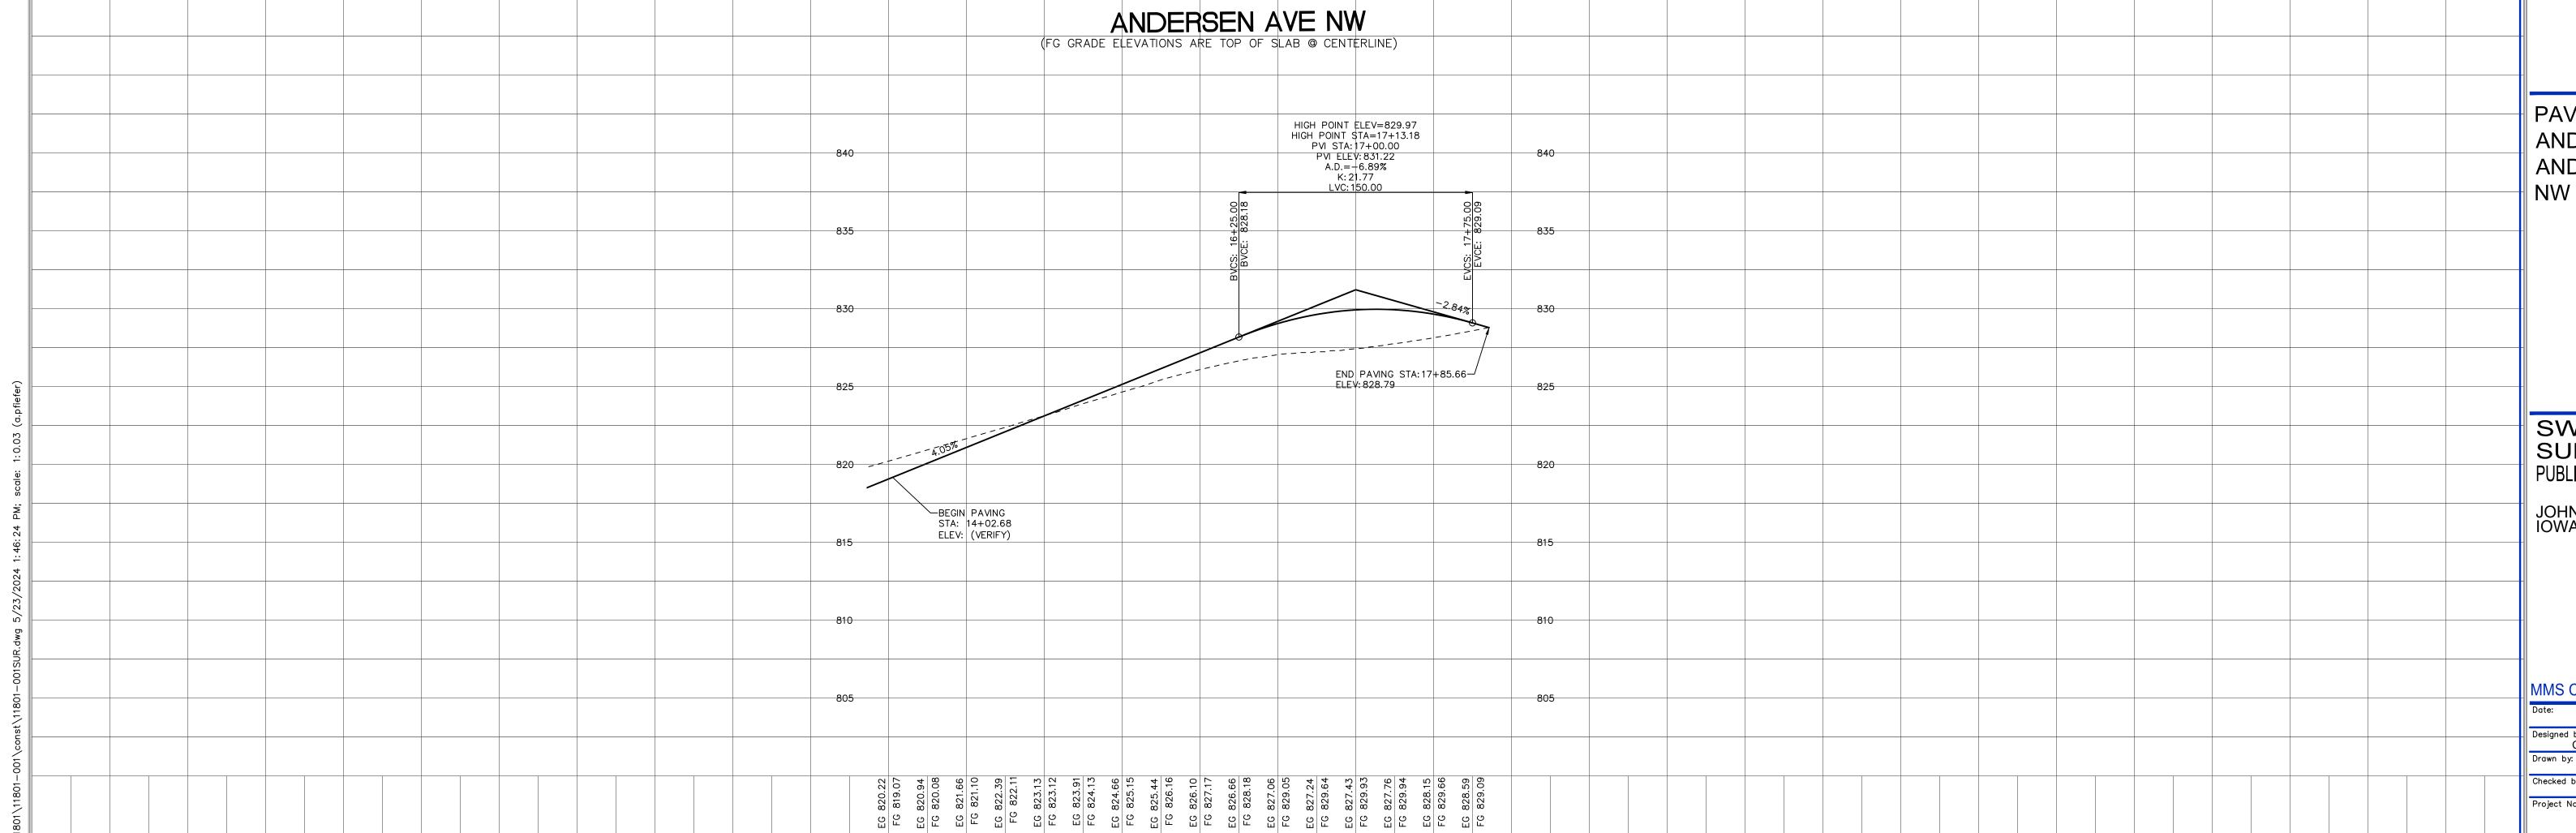

SEE SHEET CP401 FOR INTERSECTION DETAIL

STA: 14+02.68 BEGIN PAVING

1232.46

WAY NW


CIVIL ENGINEERS LAND PLANNERS LAND SURVEYORS LANDSCAPE ARCHITECTS ENVIRONMENTAL SPECIALISTS 1917 S. GILBERT ST. IOWA CITY, IOWA 52240 (319) 351-8282


PAVING PLAN AND PROFILE: ANDERSEN AVE

SWISHER 60 SUBDIVISION PUBLIC IMPROVEMENTS

JOHNSON COUNTY IOWA

MMS CONSULTANTS, INC. 05-03-2024 Designed by: CAT/LSS

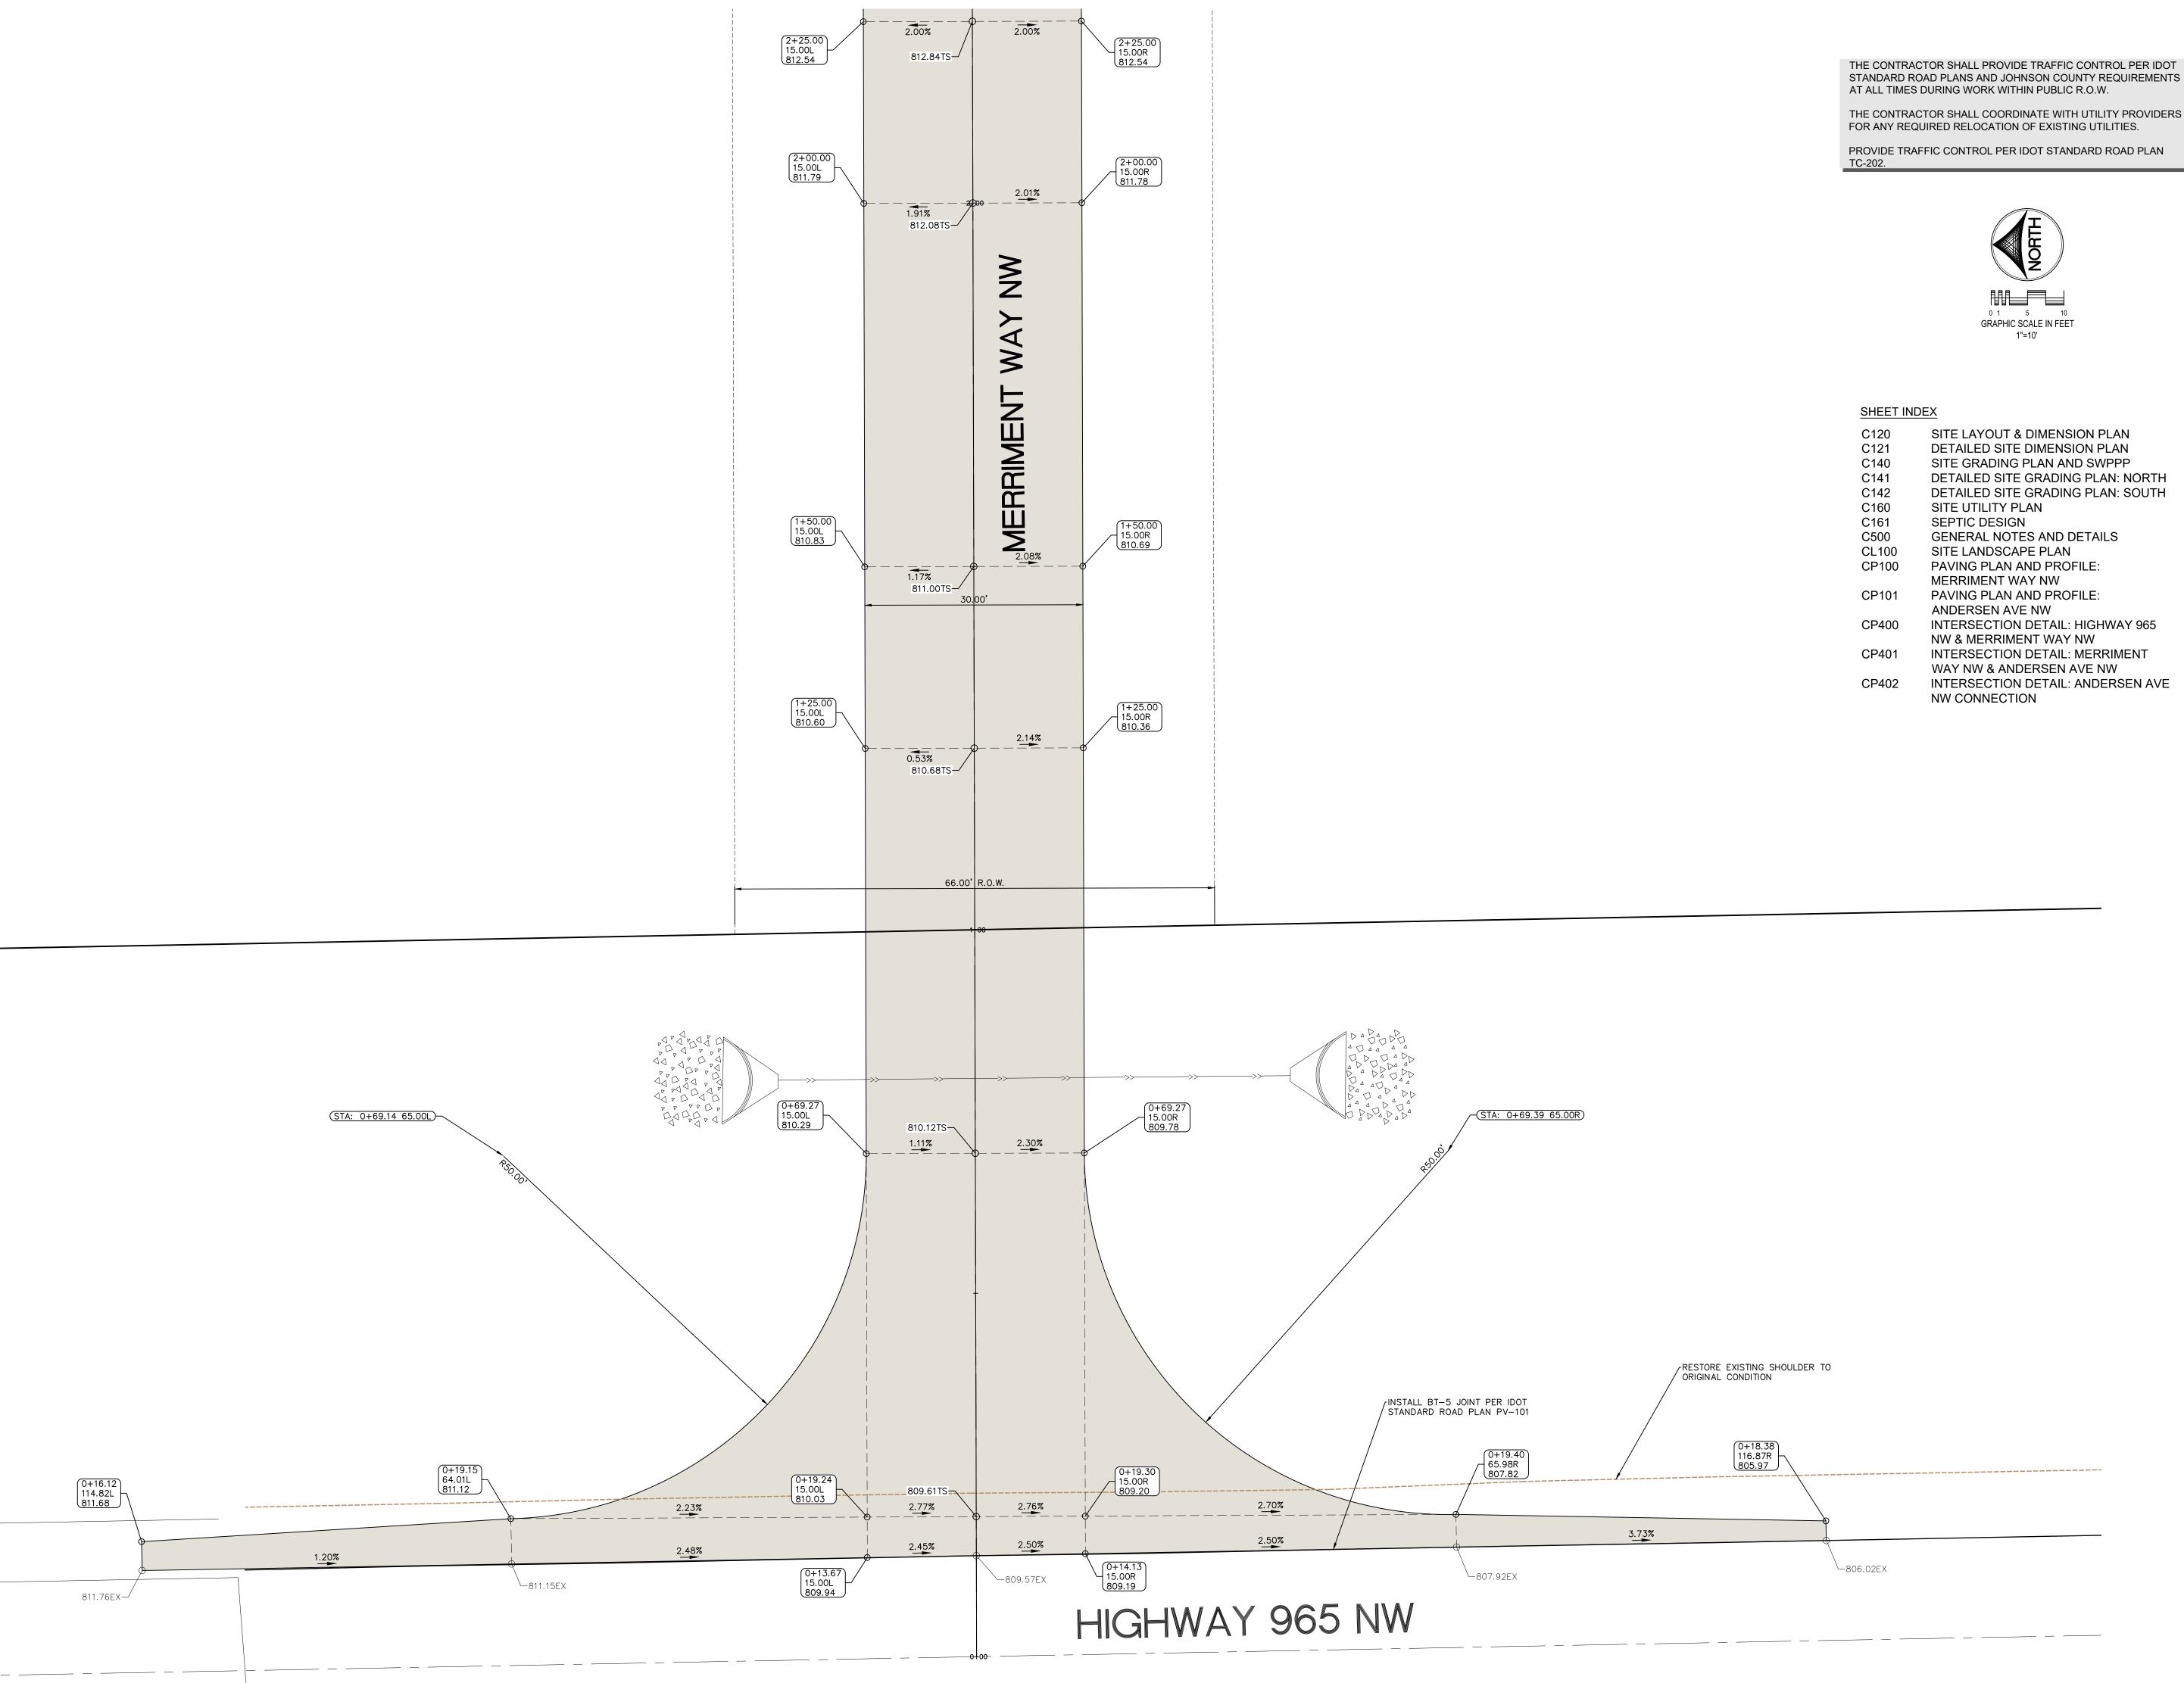

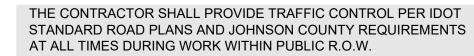

DETAILED SITE GRADING PLAN: NORTH DETAILED SITE GRADING PLAN: SOUTH

> INTERSECTION **DETAIL**: HIGHWAY 965 NW & **MERRIMENT** WAY NW

**CIVIL ENGINEERS** 

LAND PLANNERS

LAND SURVEYORS

1917 S. GILBERT ST. IOWA CITY, IOWA 52240

(319) 351-8282

LANDSCAPE ARCHITECTS

www.mmsconsultants.net

**ENVIRONMENTAL SPECIALISTS** 


Date Revision

# SWISHER 60 SUBDIVISION PUBLIC IMPROVEMENTS

JOHNSON COUNTY IOWA

MS CONSULTANTS, IN					
te:	05 02 2024				

	Date:		05-03-2024		
	Designed by: CA	Γ/LSS	Field Book No:		
	Drawn by:	ADP	Scale:	1"=10"	
	Checked by:	CAT	Sheet No	:	
	Project No:		CF	400	

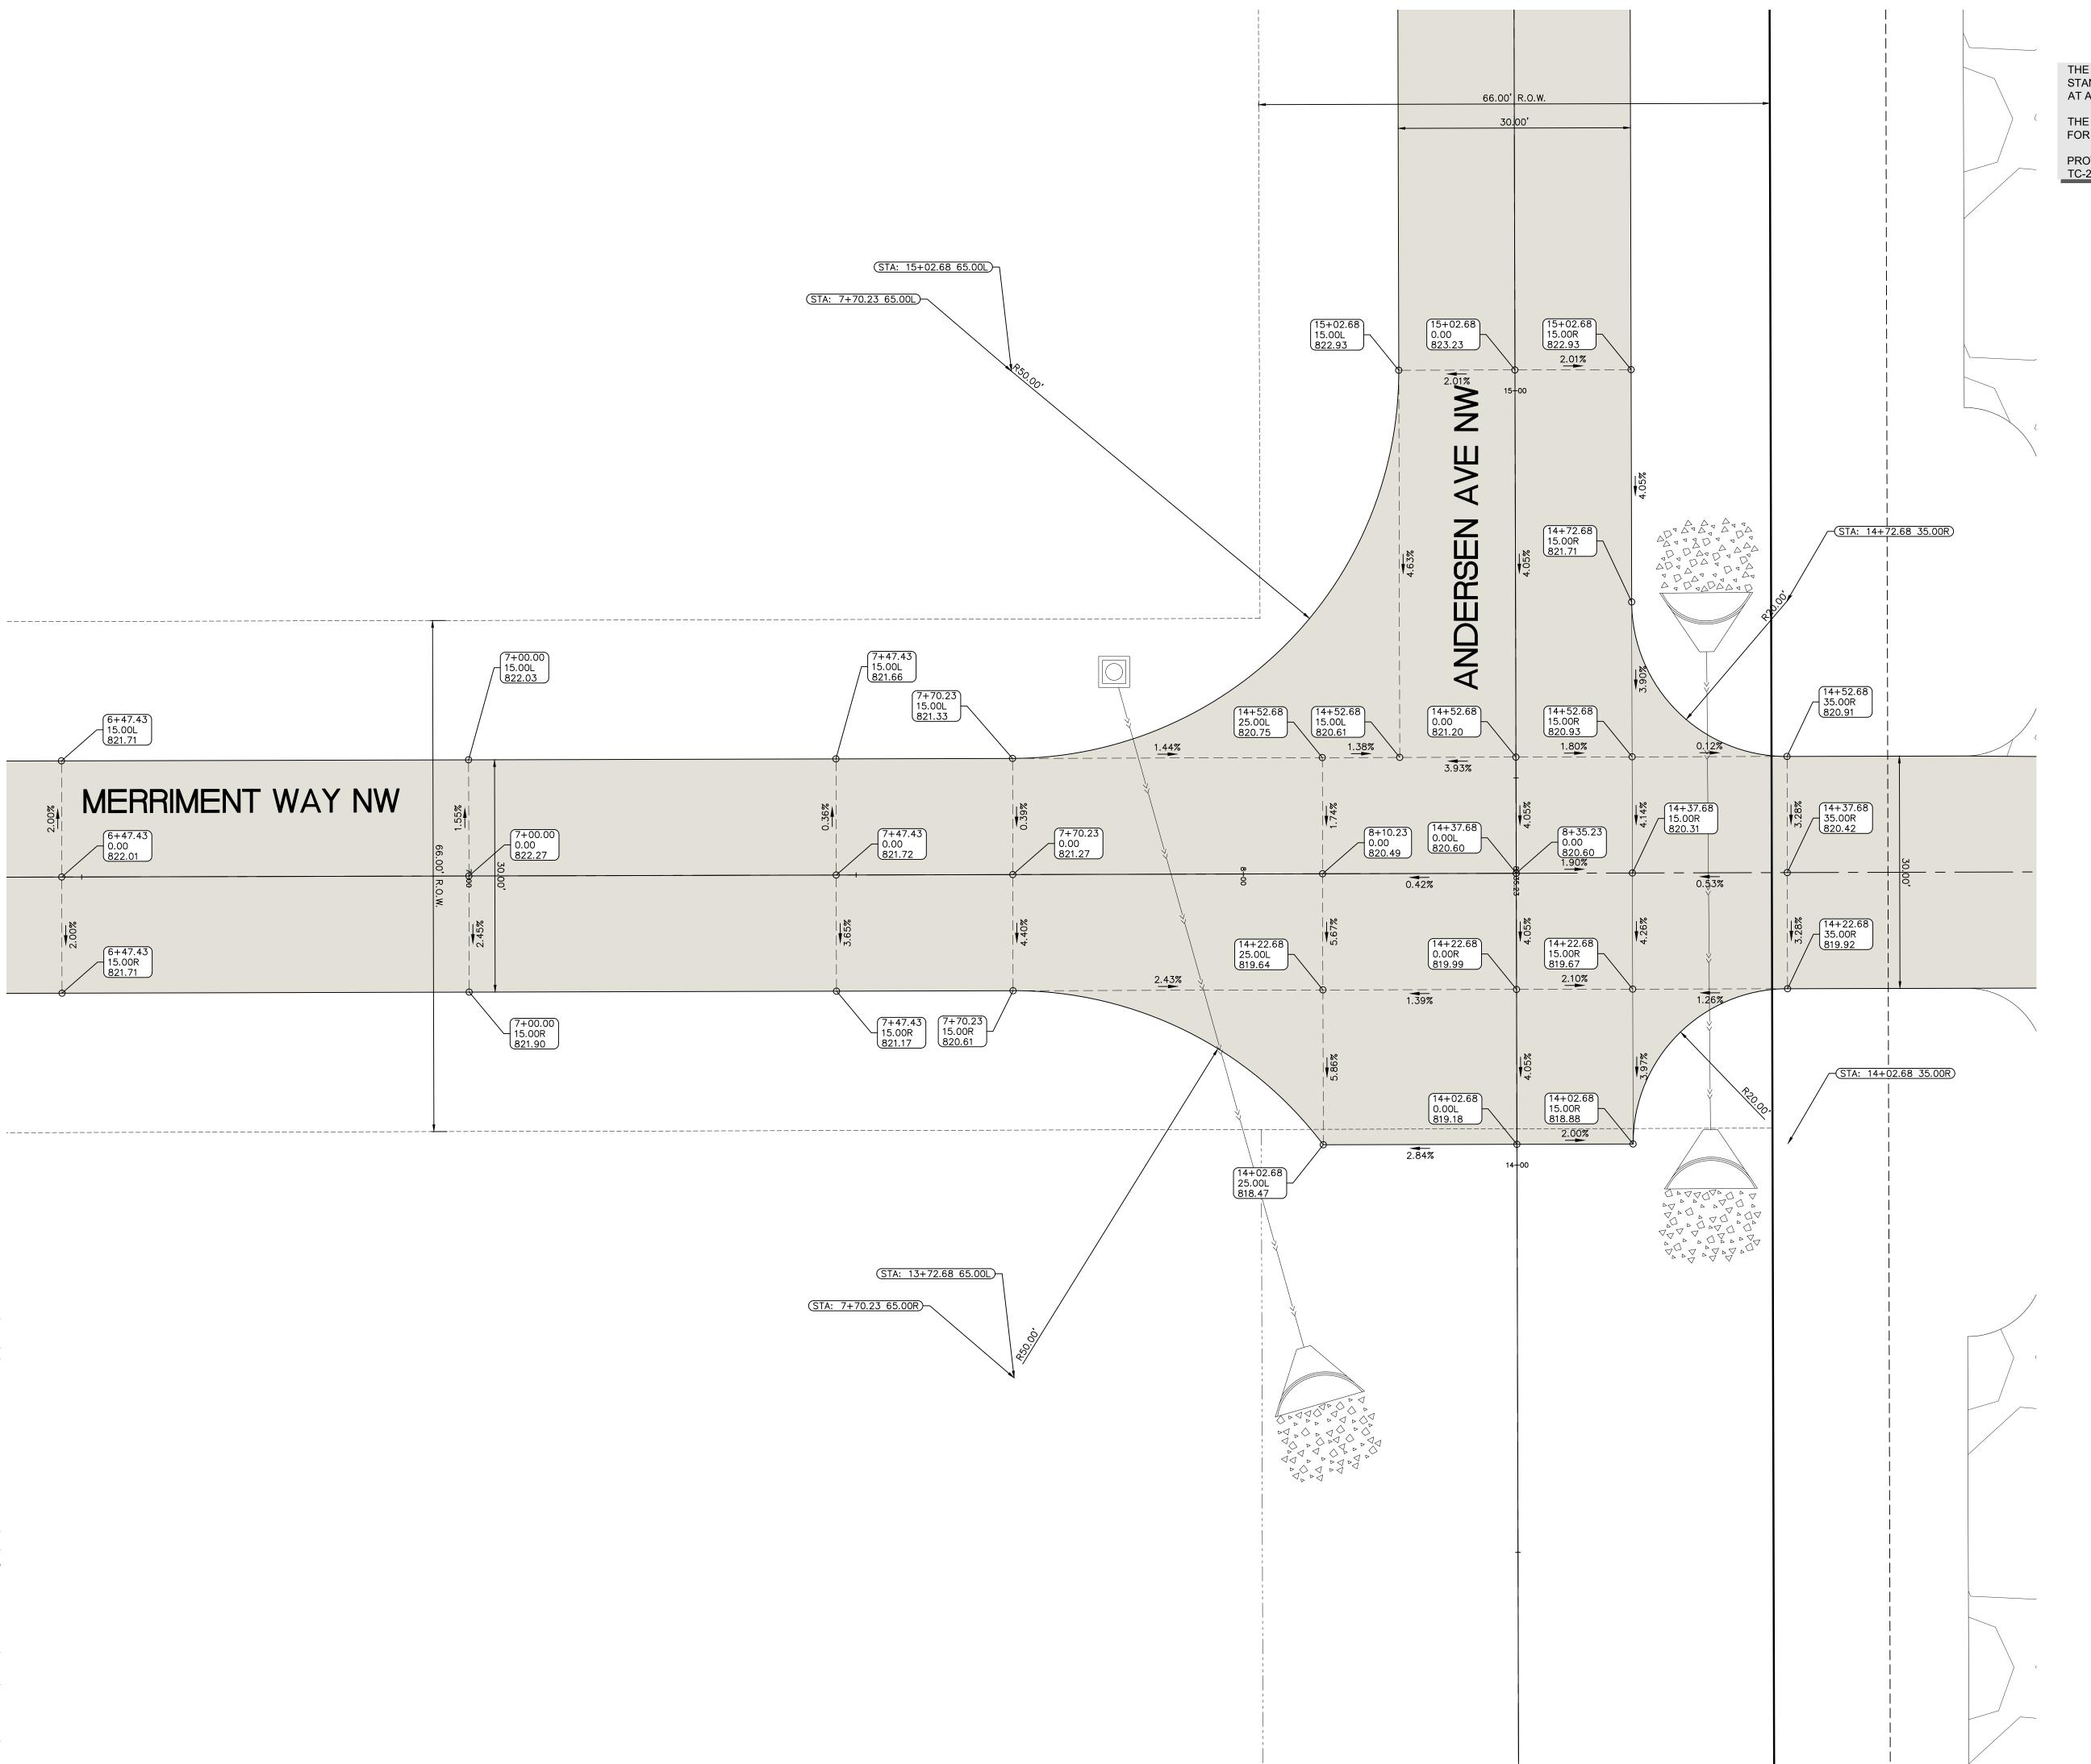

THE CONTRACTOR SHALL PROVIDE TRAFFIC CONTROL PER IDOT STANDARD ROAD PLANS AND JOHNSON COUNTY REQUIREMENTS AT ALL TIMES DURING WORK WITHIN PUBLIC R.O.W.

THE CONTRACTOR SHALL COORDINATE WITH UTILITY PROVIDERS FOR ANY REQUIRED RELOCATION OF EXISTING UTILITIES.

PROVIDE TRAFFIC CONTROL PER IDOT STANDARD ROAD PLAN



#### SHEET INDEX

SITE LAYOUT & DIMENSION PLAN C121 DETAILED SITE DIMENSION PLAN C140 SITE GRADING PLAN AND SWPPP C141 DETAILED SITE GRADING PLAN: NORTH C142 DETAILED SITE GRADING PLAN: SOUTH C160 SITE UTILITY PLAN C161 SEPTIC DESIGN C500 GENERAL NOTES AND DETAILS CL100 SITE LANDSCAPE PLAN PAVING PLAN AND PROFILE: MERRIMENT WAY NW PAVING PLAN AND PROFILE: ANDERSEN AVE NW

INTERSECTION DETAIL: HIGHWAY 965 NW & MERRIMENT WAY NW INTERSECTION DETAIL: MERRIMENT WAY NW & ANDERSEN AVE NW

> INTERSECTION DETAIL: ANDERSEN AVE NW CONNECTION



CIVIL ENGINEERS LAND PLANNERS LAND SURVEYORS LANDSCAPE ARCHITECTS **ENVIRONMENTAL SPECIALISTS** 1917 S. GILBERT ST. IOWA CITY, IOWA 52240 (319) 351-8282 www.mmsconsultants.net

Date Revision


INTERSECTION DETAIL: **MERRIMENT** WAY NW & ANDERSEN AVE NW

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INTERSECTION DETAIL: HIGHWAY 965 NW & MERRIMENT WAY NW INTERSECTION DETAIL: MERRIMENT

WAY NW & ANDERSEN AVE NW

INTERSECTION DETAIL: ANDERSEN AVE **NW CONNECTION** 

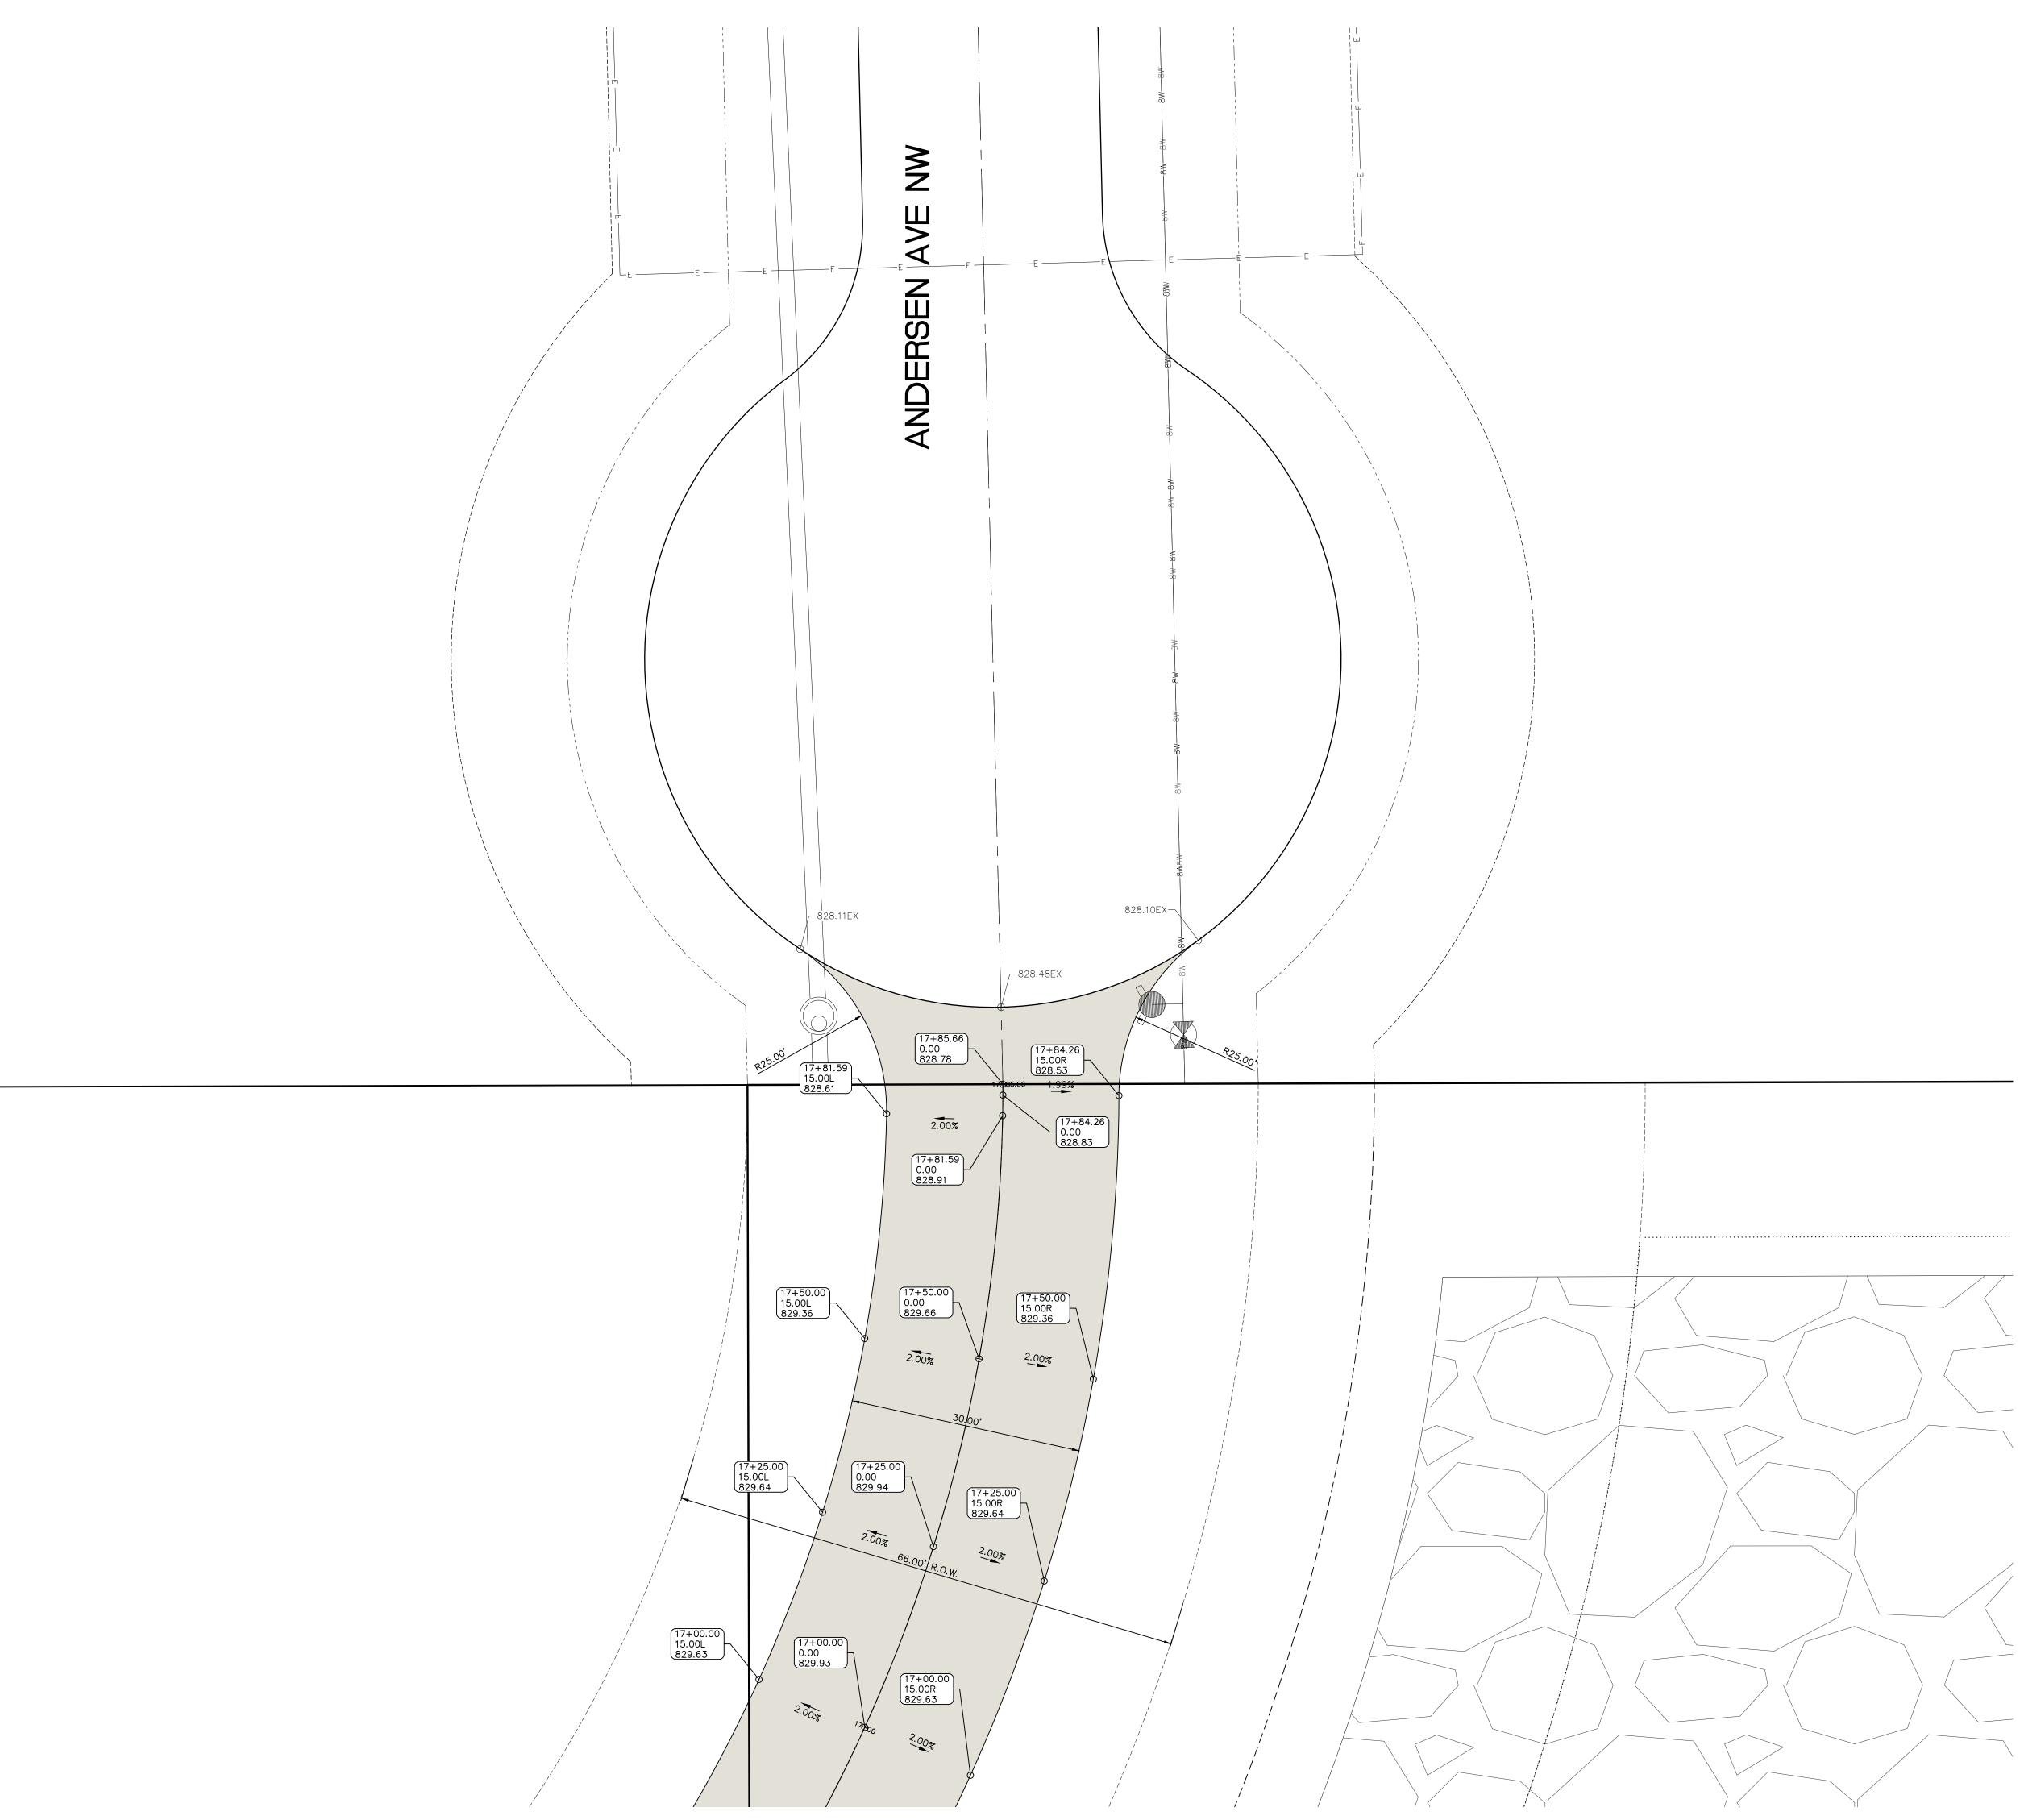

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INTERSECTION **DETAIL**: ANDERSEN AVE NW CONNECTION

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JOHNSON COUNTY IOWA

MMS CONSULTANTS INC.

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