Office Use Only Date Filed Fee

Proposed Use of Structure(s): Warehouse

P2C-24- 285 \$ 4
Application Number





JOHNSON COUNTY, IOWA

APPLICATION FOR: SITE PLAN REVIEW

In accordance with chapter 8:1.25 of the Johnson County Unified Development Ordinance, a site plan shall be reviewed prior to issuance of a building permit in the RR, C, CH, AG-T, C-AG, ML, MH, and SWDRR zoning districts, and prior to commencing certain conditional uses permitted by the Board of Adjustment where required by Chapter 8:1.23.

Address of Location: 2698 Rese	rvoir Drive NW		
Subdivision Name and Lot Nu	mber: Lot 1 Corridor Industrial Park		
Current Zoning: ML	Parcel Number: 0322377015		
	ications are not subject to the standard filing deadlines for development itted at any time. Once complete, they will be placed on the next available Board		
affirms that the owner(s) of the said owners hereby give their conduct a site visit and photogra	PLEASE PRINT OR TYPE information provided herein is true and correct. If applicant is not the owner, applicant property described on this application consent to this application being submitted, and onsent for the office of Johnson County Planning, Development, and Sustainability to ph the subject property.		
affirms that the owner(s) of the said owners hereby give their of	information provided herein is true and correct. If applicant is not the owner, applicant property described on this application consent to this application being submitted, and consent for the office of Johnson County Planning, Development, and Sustainability to		
affirms that the owner(s) of the said owners hereby give their o conduct a site visit and photogra Hajek Realty Company, LLC	information provided herein is true and correct. If applicant is not the owner, applicant property described on this application consent to this application being submitted, and onsent for the office of Johnson County Planning, Development, and Sustainability to ph the subject property. Name of Applicant (if different) wa 52317		
affirms that the owner(s) of the said owners hereby give their conduct a site visit and photograted Hajek Realty Company, LLC Name of Owner 10 N. George Street, North Liberty, Ice	information provided herein is true and correct. If applicant is not the owner, applicant property described on this application consent to this application being submitted, and onsent for the office of Johnson County Planning, Development, and Sustainability to ph the subject property. Name of Applicant (if different) wa 52317		

See back page for Application Submittal Requirements and Checklist

The following items must be submitted for the application to be complete. Once submitted, county staff will review the materials and request revisions (if necessary). Once all revisions and outside reviews have been will be placed on the next available Board of Supervisors agenda.

Electronic submissions – including CAD or GIS line work – should be submitted in accordance with the PS 140024 ment's electronic submission guidelines (see below). Preference is that electronic submission is provided prior to hard copy submission.

PLANNING.

PLANNING.

PLANNING.

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PLANNING.

<u>Initial each item below</u> to confirm that you are aware of the submittal requirements for an application to be considered complete.

A letter of intent explaining the proposed use including but not limited to the type of business, number of employees, parking facilities proposed, days and hours of operation, provisions for water and wastewater, type of equipment to be used, and signage.

Two (2) copies of the site plan which includes all information required by section 8:1.25 of the Johnson County Unified Development Ordinance, including:

- jdm Landscape Plan should be a dedicated sheet
- jdm Grading Plan, including Erosion and Sediment Control Plan/SWPPP should be a dedicated sheet.
- <u>jdm</u> Paving detail for entrances, drives, parking areas can be included on other sheets or be on a dedicated sheet.
- Sensitive Areas Exhibit (delineations from the Sensitive Areas Report, shown on a dedicated sheet at the same scale as the site plan. This exhibit should show all proposed disturbance on the site including proposed building footprints and the extent of any grading).
- A copy of an approved ROW Permit (Access Permit) from Johnson County Secondary Roads or Iowa DOT for access sufficient to serve the use proposed in the application.
- jdm Application Fee (\$250) is due at the time of submittal.
- jdm One (1) copy of the Sensitive Areas Analysis in compliance with the Sensitive Areas Ordinance.
- One (1) copy of the Stormwater Management Plan (including soil erosion and sediment control) in compliance with the Stormwater Management regulations, or an approved waiver.

<u>Electronic Submission Requirements</u> — an electronic submission of all hard-copy materials required above should be submitted prior to hard copy delivery. In all cases, electronic submission is due by 12 noon the day after the submittal deadline for the application to be considered complete. Electronic submissions should include, and conform with, the following:

<u>jdm</u> Electronic or digitized copy (CAD line work or GIS geodatabase) of proposed plat in .dwg format (.dxf is also acceptable if .dwg is not an option. No .zip files will be accepted).

- Submission must be saved in AutoCAD 2007 or older format.
- Submissions must use Coordinate System: NAD_1983_StatePlane_lowa_South_FIPS_1402_Feet
- If applicable, submission <u>should include</u> existing structures (if any), property lines, road right-of-way lines, required setback lines, and requested setback lines.
- Submission <u>MUST</u> include information for Sensitive Areas Analysis/Mapping and Stormwater/Soil Erosion Control infrastructure on the site. This includes any limits of disturbance or other impact areas.
- Submission should **NOT** include legends, legal descriptions, location maps, signature blocks, etc.

A PDF of the entire application packet. A single PDF preferred; but a separate PDF for site plan, application materials, sensitive areas documentation, stormwater plan, and legal documents (if applicable) is acceptable.



JUL 3 1 2024

1917 S. Gilbert Street lowa City, lowa 52240 **319.351.8282**

mmsconsultants.net mms@mmsconsultants.net

July 29, 2024

Mr. Josh Busard Johnson County Planning, Development, & Sustainability Dept. 913 S. Dubuque St, Suite 204 Iowa City, IA 52240

RE: Lot 1, Corridor Industrial Park

On behalf of Hajek Realty Company LLC, we are submitting a site plan for Lot 1 of Corridor Industrial park. Lot 1 is currently zoned Light Industrial (ML) and is 1.85 acres in size. The site plan proposes the construction of a 2,880 square foot building. The site contains three existing buildings.

Main access to Lot 1 already exists to the site with connections to Reservoir Drive NW and Highway 965 NW.

The proposed building will be served by the existing water supply and wastewater facility that serves the subdivision

Please feel free to reach out with any questions or concerns.

Respectfully submitted,

Jon D. Marner

11987-001L1.docx

MMS Consultants, Inc.
Experts in Planning and Development Since 1975

JUL 3 1 2024

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PL

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319.351.8282

mmsconsultants.net mms@mmsconsultants.net

LETTER OF TRANSMITTAL

Johnson County PDS TO: 913 S Dubuque Street, Suite 204 lowa City, Iowa 52240

These are transmitted as checked below:

Date: 07/31/24 Project #: 11987-001

From: Jon Marner

RE: Lot 1 Corridor Industrial Park

We are sending you the following attached items: Via Hand Delivered

COPIES	DATE	PROJECT NO.	DESCRIPTION	
1	07/30/24	11987-001	Site plan	
1		11987-001	Letter of intent	
1		11987-001	Site plan review application	
1		1.1987-001	Application fee \$250 - check #1031	
			Δ	

☐ For approval ☐ For your use ☐ As requested ☐ For review & comment	☐ Approved as submitted ☐ Approved as noted ☐ Returned as noted ☐ Prints returned after loan to us	 ☐ For Approval & Signature ☐ Submit copies for distribution ☐ For Recording ☐ Other
REMARKS:		
Jon D. Marner MMS Consultants, Inc.		
COPY TO:		
Received by:	Date:	Time:

IF ENCLOSURES ARE NOT NOTED, KINDLY NOTIFY US AT ONCE.

MMS CONSULTANTS, INC. 07/18/2024 Designed by: Drawn by: Checked by: Project No:

CUMMINGS

1.85 AC

CIVIL ENGINEERS

LAND PLANNERS

(319) 351-8282

CIVIL ENGINEERS

LAND PLANNERS

1917 S. GILBERT ST.

(319) 351-8282


SITE PLAN LOT 1, CORRIDOR INDUSTRIAL PARK JOHNSON COUNTY, IOWA PLAN PREPARED BY: MMS CONSULTANTS INC. OWNER/APPLICANT: HAJEK REALTY COMPANY LLC


1917 S. GILBERT STREET 10 N GEORGE ST IOWA CITY, IOWA 52240 NORTH LIBERTY, IOWA 52317

SITE LAYOUT AND DIMENSION PLAN SITE DEMO PLAN OVERALL SITE GRADING AND EROSION CONTROL PLAN DETAILED SITE GRADING PLAN C160 SITE UTILITY PLAN C500 GENERAL NOTES AND DETAILS


SITE LANDSCAPE PLAN

L100

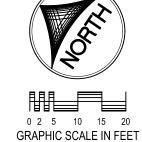

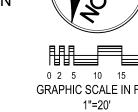

STANDARD LEGEND AND NOTES

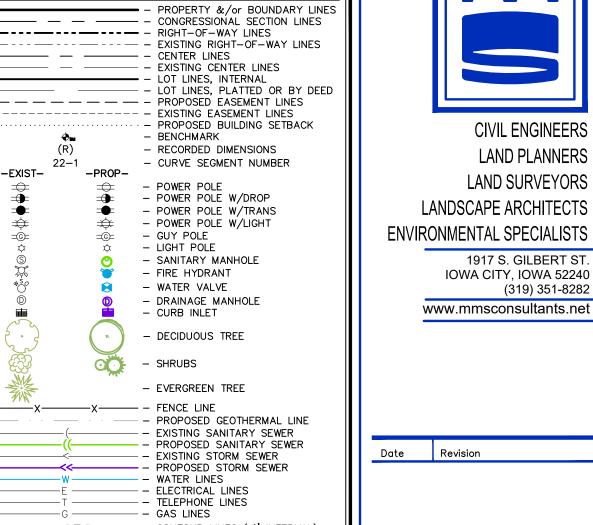

SITE DEMO PLAN


LOT 1, CORRIDOR INDUSTRIAL PARK


JOHNSON COUNTY IOWA

THE CONTRACTOR SHALL NOTIFY IOWA ONE CALL AT 811 OR 800/292-8989

NO LESS THAN 48 HRS. IN ADVANCE OF ANY DIGGING OR EXCAVATION. WHERE PUBLIC UTILITY FIXTURES ARE SHOWN AS EXISTING ON THE PLANS OR ENCOUNTERED WITHIN THE CONSTRUCTION AREA, IT SHALL BE THE RESPONSIBILITY OF THE CONTRACTOR TO NOTIFY THE OWNERS OF THOSE UTILITIES PRIOR TO THE BEGINNING OF ANY CONSTRUCTION. THE CONTRACTOR SHALL AFFORD ACCESS TO THESE FACILITIES FOR NECESSARY MODIFICATION OF SERVICES. UNDERGROUND FACILITIES, STRUCTURES AND UTILITIES HAVE BEEN PLOTTED FROM AVAILABLE SURVEYS AND RECORDS, AND THEREFORE THEIR LOCATIONS MUST BE CONSIDERED APPROXIMATE ONLY. IT IS POSSIBLE THERE MAY BE OTHERS, THE EXISTENCE OF WHICH IS PRESENTLY NOT KNOWN OR SHOWN. IT IS THE CONTRACTOR'S RESPONSIBILITY TO DETERMINE THEIR EXISTENCE AND EXACT LOCATION AND TO AVOID DAMAGE THERETO. NO CLAIMS FOR ADDITIONAL COMPENSATION WILL BE

ALLOWED TO THE CONTRACTOR FOR ANY INTERFERENCE OR DELAY CAUSED BY SUCH WORK.

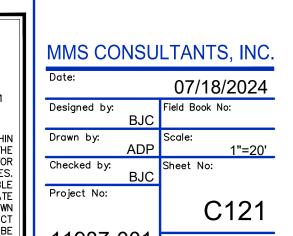

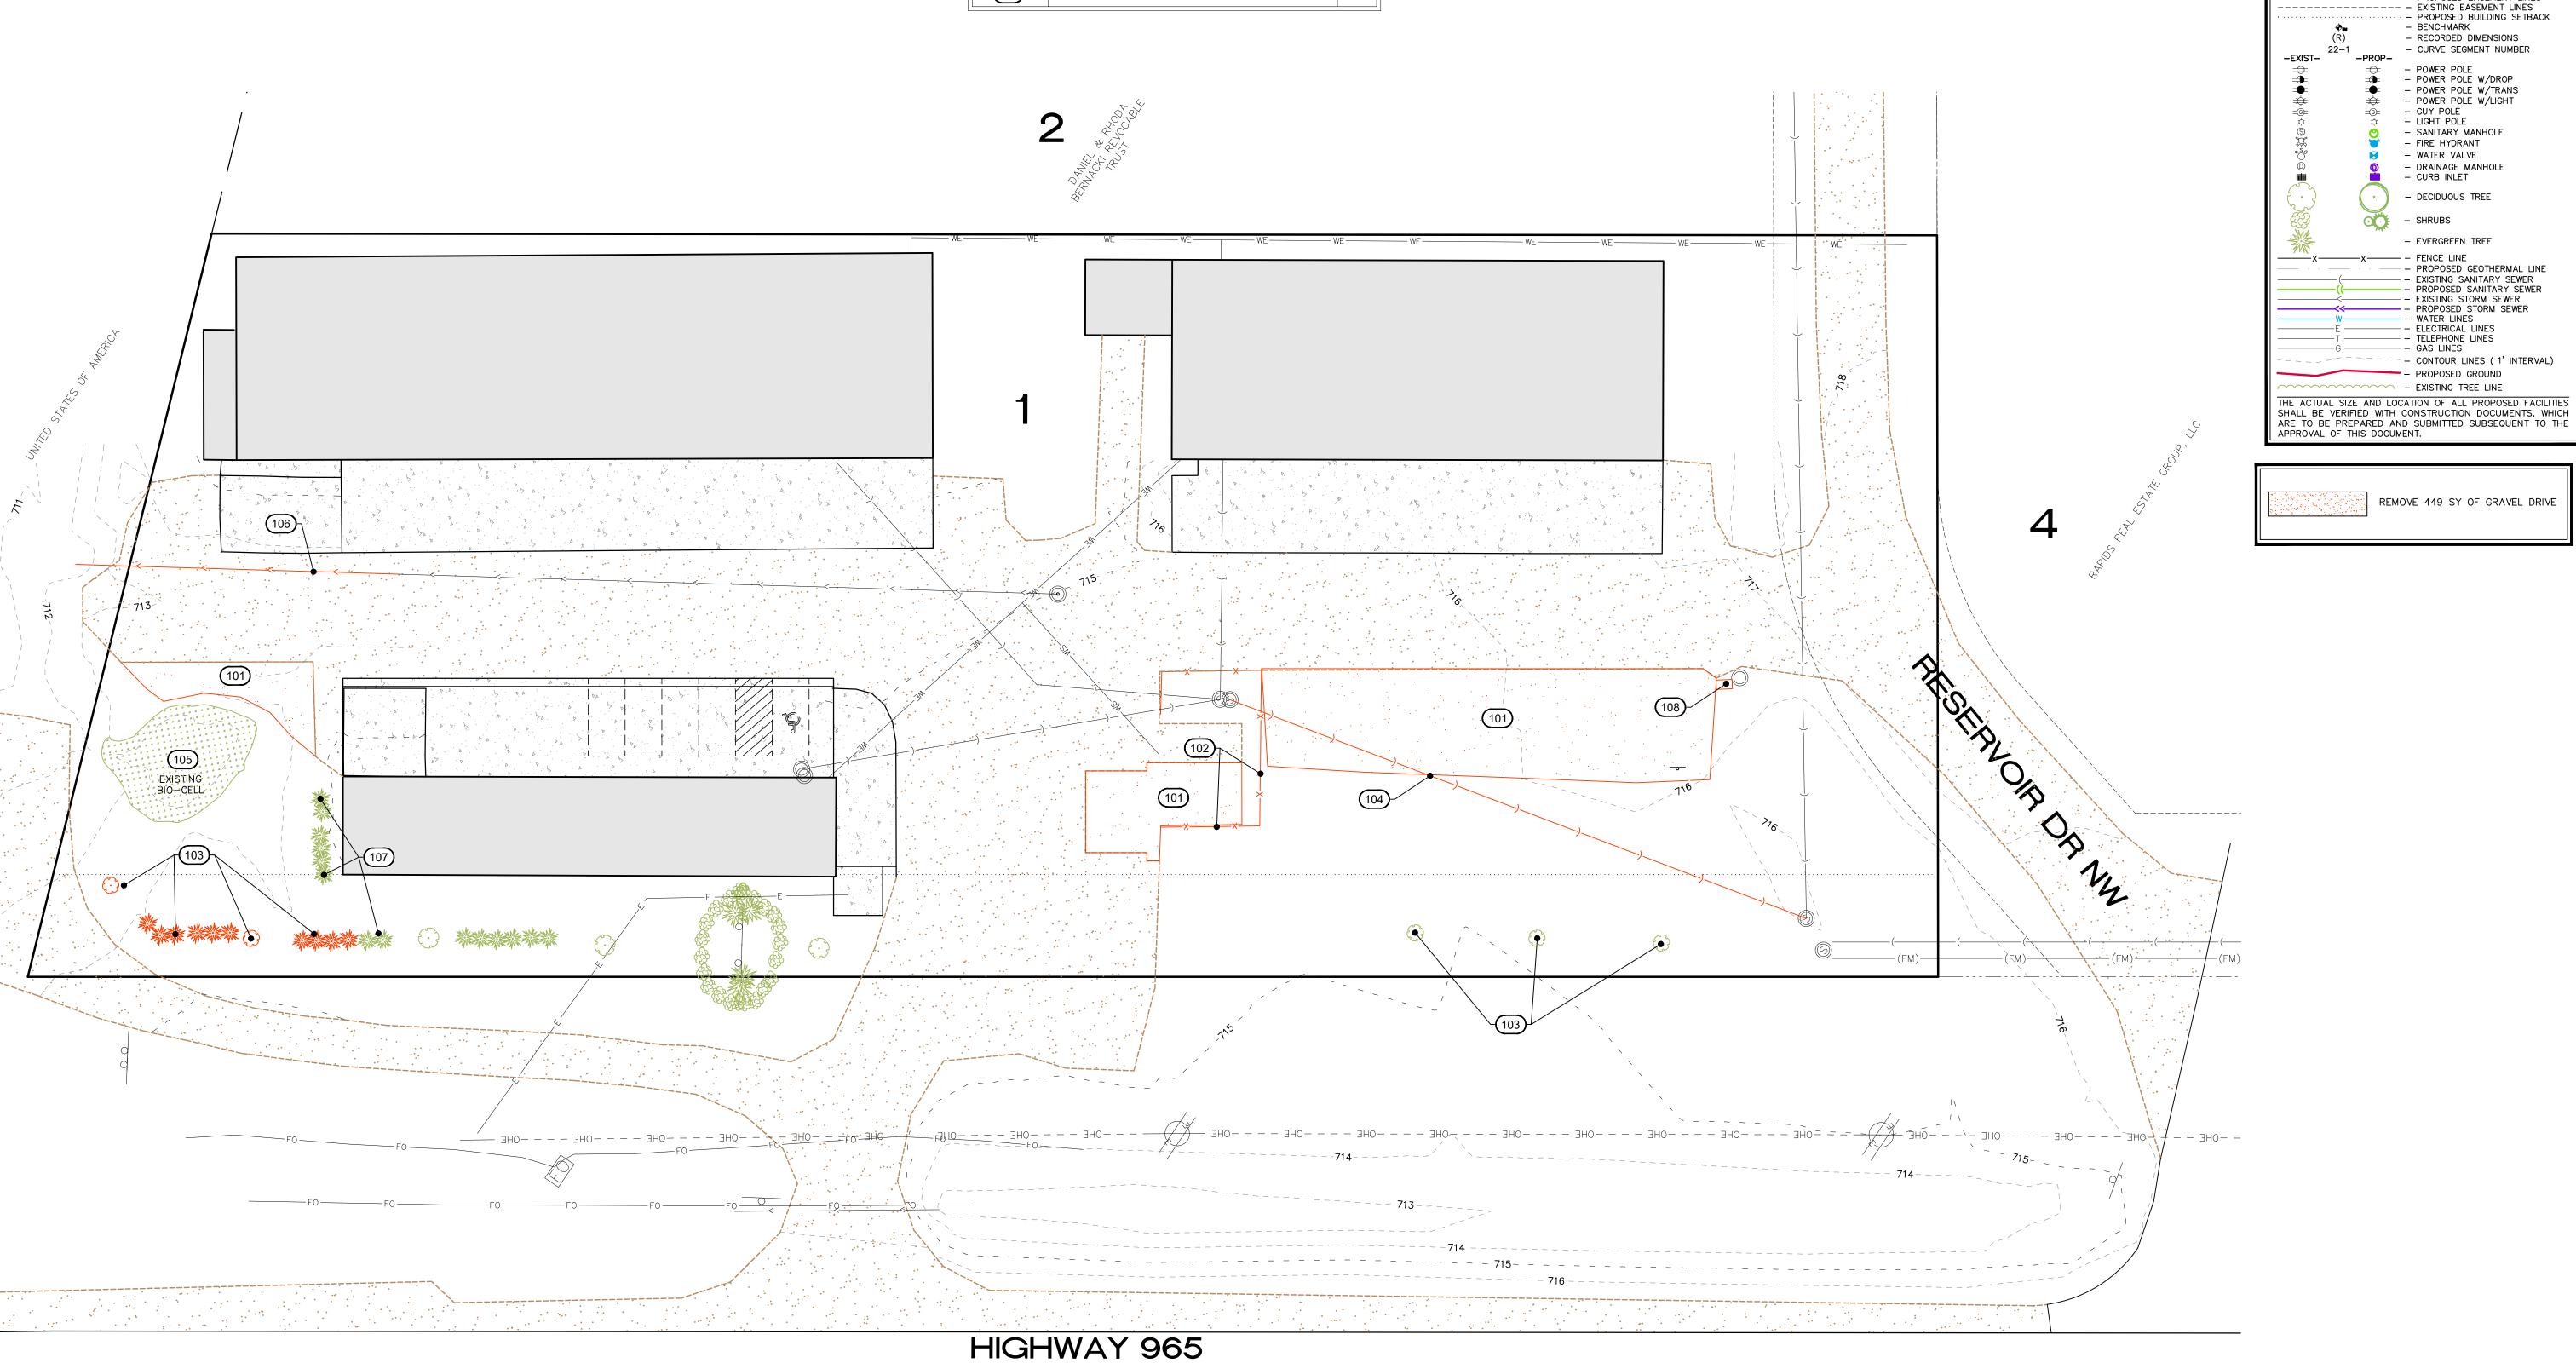

DEMO

104

NUMBER KEYNOTE

REMOVE EXISTING GRAVEL DRIVE

REMOVE EXISTING SANITARY PIPE

REMOVE 79 LF OF EXST 6" DRAIN PIPE

REMOVE EXISTING BIO-CELL

PROTECT EXISTING PLANTINGS

RELOCATE EXISTING MAILBOX

TRANSPLANT EXISTING PLANTINGS PER SHEET L100

REMOVE EXISTING FENCE

GRADING AND EROSION CONTROL NOTES

STABILIZATION SEEDING

STABILIZATION SEEDING SHALL BE IN ACCORDANCE WITH SUDAS

APPLICATION RATE lb/acre

40

95

FFE = 717.04

SECTION 9010.2.02 SEED MIXTURES AND SEEDING DATES.

COMMON NAME

PRING - MARCH 1 - MAY 20

SUMMER - MAY 21 - AUGUST 14

ALL - AUGUST 15 - SEPTEMBER 30

HIGHWAY 965

* ENGINEER MAY DELETE FOR PREVIOUSLY ESTABLISHED URBAN AREAS.

FERTILIZER SHALL BE APPLIED AT A RATE OF 300 LBS PER ACRE USING CHEMICALLY

COMBINED COMMERCIAL 13-13-13 FERTILIZER (SUDAS SECTION 9010.2.03 A.2)

NNUAL RYEGRASS

ANNUAL RYEGRASS

ANNUAL RYEGRASS

GRAIN RYE

TABLE 9010.06: TYPE 4 SEED MIXTURE

TOTAL SITE AREA: 1.85 ACRES TOTAL AREA TO BE DISTURBED: 0.51 ACRES

EROSION CONTROL MEASURES SHOWN SHALL BE USED DURING FILL ACTIVITIES. EROSION CONTROL MEASURES SHALL BE REEVALUATED AND MODIFIED, IF NECESSARY, AT THE TIME OF SITE DEVELOPMENT. ADDITIONAL EROSION AND SEDIMENT CONTROL MEASURES THAT COULD BE USED ON SITE, IF NEEDED, CAN BE FOUND IN APPENDIX D OF THE STORM WATER POLLUTION PREVENTION PLAN (SWPPP) BINDER PREPARED FOR THE SITE. IF ADDITIONAL MEASURES ARE USED, INDICATE THE

CONTRACTOR SHALL INSTALL A ROCK ENTRANCE AND PERFORM REGULAR CLEANING OF VEHICLES THAT LEAVE THE SITE.

TYPE AND LOCATION OF SAID MEASURE ON THIS PLAN.

FOLLOWING INSTALLATION OF PERIMETER SILT FENCE AND TEMPORARY CONSTRUCTION ENTRANCE THE CONTRACTOR SHALL CONTACT THE CITY INSPECTOR TO SCHEDULE A SITE INSPECTION PRIOR TO ANY SOIL

THE CONTRACTOR SHALL FOLLOW THE NPDES PERMIT, SWPPP, AND THE COUNTY CSR REGULATIONS. THE EROSION CONTROL CONTRACTOR SHALL INSTALL FILTER SOCKS OR OTHER APPROVED FORM OF INLET PROTECTION AT EACH STREET INTAKE

EROSION CONTROL MEASURES, INCLUDING, BUT NOT LIMITED TO, TEMPORARY ROCK CONSTRUCTION ENTRANCE, CONCRETE WASHOUT. TEMPORARY PARKING AREA, AND STORAGE AREAS, SHALL BE CONSTRUCTED IN ACCORDANCE WITH SECTION 9040 SUDAS STANDARD SPECIFICATIONS.

DUE TO PHASED CONSTRUCTION OF DRIVE AND BUILDING, EROSION CONTROL MEASURES SHALL BE INSTALLED AND MAINTAINED BASED ON THE PHASE AND EXTENTS OF LAND DISTURBANCE. CONTRACTOR SHALL COORDINATE WITH COUNTY INSPECTORS TO ENSURE THAT NO MATERIAL LEAVES THE SITE, AND THAT ALL DISTURBED AREAS ARE STABILIZED IN ACCORDANCE WITH JOHNSON COUNTY ENVIRONMENTAL REGULATIONS.

PROPOSED

1,197 SF K

SAND FILTER

SITE PLAN LOT 1, CORRIDOR INDUSTRIAL PARK JOHNSON COUNTY, IOWA

EROSION CONTROL MATTING IN ALL AREAS OF STORM

TEMPORARY ROCK CONSTRUCTION ENTRANCE/EXIT

BASIN/BIO CELL THAT ARE 4:1 SLOPES AND SPILLWAYS

PORTABLE RESTROOM. EPA and lowa DNR both recommend

that the unit and area are maintained clean and that the units

DOCUMENT LOCATION (PERMITS, SWPPP, INSPECTION FORMS, ETC.)

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TEMPORARY PARKING AND STORAGE

are regularly emptied.

FILTER SOCK INLET PROTECTION

CONCRETE TRUCK/EQUIPMENT WASHOUT

FILTER SOCK BEHIND CURB AT CURB RAMP

SILT FENCE/FILTER SOCK

NORTH LIBERTY, IOWA 52317

EROSION CONTROL LEGEND

THE ABOVE LISTED ITEMS ARE SHOWN IN THEIR RECOMMENDED LOCATIONS. IF A CONTROL MEASURE IS ADDED OR MOVED TO A MORE SUITABLE LOCATION,

INDICATE THE REVISION ON THIS SHEET. THE BLANKS LEFT FOR OTHER MEASURES SHOULD BE USED IF AN ITEM NOT SHOWN ABOVE IS IMPLEMENTED ON

SITE, ADDITIONAL PRACTICES FOR EROSION PREVENTION AND SEDIMENT CONTROL CAN BE FOUND IN APPENDIX D OF THE SWPPP.

PROPOSED LIMITS OF

PERIMETER SILT FENCE

SITE LAYOUT AND DIMENSION PLAN SITE DEMO PLAN OVERALL SITE GRADING AND EROSION CONTROL PLAN DETAILED SITE GRADING PLAN

-EXIST-

SITE UTILITY PLAN **GENERAL NOTES AND DETAILS** SITE LANDSCAPE PLAN

C160

C500

L100

DUMPSTER FOR CONSTRUCTION WASTE. Provide a covered

dumpster which is recommended by the City of Iowa City

and EPA for construction storm water pollution prevention.

See Page 30 of the EPA's Developing Your Storm Water

Pollution Prevention Plan, A Guide for Construction Sites,

TEMPORARY SOIL STOCKPILE AREA

EPA-833-R-06-004, May 2007.

RIP RAP OUTLET PROTECTION

DIRECTION OF OVERLAND FLOW


OTHER MEASURE:

OTHER MEASURE:

OTHER MEASURE:



GRAPHIC SCALE IN FEET 1"=20'

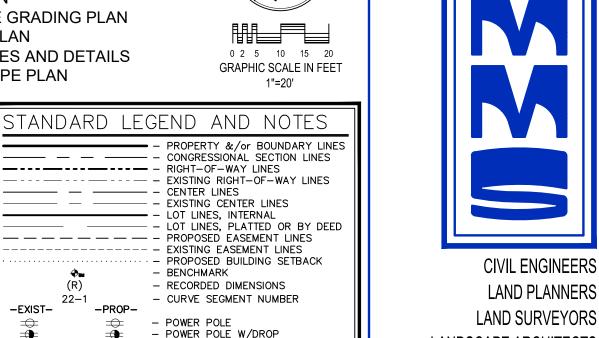

LAND SURVEYORS LANDSCAPE ARCHITECTS **ENVIRONMENTAL SPECIALISTS** 1917 S. GILBERT ST. IOWA CITY, IOWA 52240 (319) 351-8282 www.mmsconsultants.net

- EVERGREEN TREE X—X— – FENCE LINE - PROPOSED GEOTHERMAL LINE - EXISTING SANITARY SEWER - EXISTING STORM SEWER - PROPOSED STORM SEWER WATER LINES ELECTRICAL LINES - TELEPHONE LINES — – GAS LINES - - CONTOUR LINES (1' INTERVAL) - PROPOSED GROUND - EXISTING TREE LINE THE ACTUAL SIZE AND LOCATION OF ALL PROPOSED FACILITIES SHALL BE VERIFIED WITH CONSTRUCTION DOCUMENTS, WHICH ARE TO BE PREPARED AND SUBMITTED SUBSEQUENT TO THE APPROVAL OF THIS DOCUMENT. SILT FENCE DETAIL

> — COMPACTED NATIVE SOIL BACKFILL FILTER FABRIC -

---- - RIGHT-OF-WAY LINES

-PROP-

- CENTER LINES

- - - - - - - - PROPOSED EASEMENT LINES

- EXISTING CENTER LINES

EXISTING EASEMENT LINES

- RECORDED DIMENSIONS

- POWER POLE W/DROP

- POWER POLE W/TRANS

- POWER POLE W/LIGHT

- SANITARY MANHOLE

- DRAINAGE MANHOLE

- DECIDUOUS TREE

GUY POLE

LIGHT POLE

FIRE HYDRANT

WATER VALVE


CURB INLET

SHRUBS

CURVE SEGMENT NUMBER

- PROPOSED BUILDING SETBACK

LOT LINES, INTERNAL

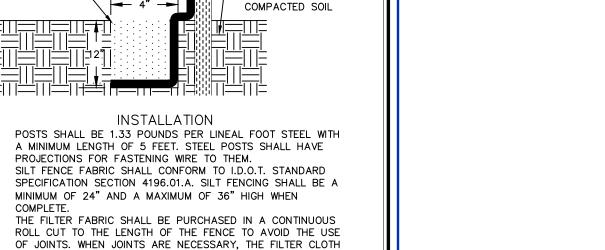

STEEL POST

- UNDISTURBED OR

ALIGNMENT. POSTS SHALL BE DRIVEN INTO THE GROUND A MINIMUM OF 28". 5. A TRENCH SHALL BE EXCAVATED APPROXIMATELY 4" WIDE BY 12" DEEP ALONG THE UPSLOPE SIDE OF THE POSTS. FILTER FABRIC SHALL BE STAPLED OR WIRED TO THE POSTS SUCH THAT THE FABRIC EXTENDS INTO THE TRENCH AS SHOWN ABOVE. THE FABRIC SHALL BE FASTENED A MINIMUM OF THREE PLACES ON EACH POST. THE TRENCH SHALL BE BACK FILLED WITH EXCAVATED MATERIAL AND THOROUGHLY COMPACTED.

SHALL BE SPLICED TOGETHER ONLY AT A SUPPORT POST. WITH A MINIMUM 6" OVERLAP, AND SECURELY SEALED.

AND DRIVEN SECURELY INTO THE GROUND ALONG THE FENCE

POSTS SHALL BE SPACED A MAXIMUM OF 8 FEET APART

MAINTENANCE SILT FENCES SHALL BE INSPECTED WEEKLY AND AFTER EACH RAIN-FALL EVENT PRODUCING RUN-OFF, DURING PERIODS OF PROLONGED RAIN INSPECTIONS SHALL BE AT LEAST DAILY. ANY REPAIRS NEEDED TO MAINTAIN THE SILT FENCE'S EFFECTIVENESS SHALL BE MADE IMMEDIATELY. SHOULD THE FABRIC ON A SILT FENCE DECOMPOSE OR BECOME INEFFECTIVE PRIOR TO STABILIZING THE UPSLOPE AREAS THE FABRIC SHALL BE REPLACED PROMPTLY. SEDIMENT DEPOSITS SHOULD BE REMOVED AFTER EACH STORM EVENT. THEY MUST BE REMOVED WHEN THE DEPOSITS REACH APPROXIMATELY ONE-HALF THE HEIGHT OF THE FENCE. SILTS REMOVED SHALL BE PLACED IN A PROTECTED

PLACE THAT WILL PREVENT THEIR ESCAPE FROM THE CONSTRUCTION SITE. ANY SEDIMENT DEPOSITS REMAINING IN PLACE AFTER THE SILT FENCE IS NO LONGER NEEDED SHALL BE DRESSED TO CONFORM WITH THE EXISTING GRADE, PREPARED AND

5. SILT FENCE SHALL REMAIN IN PLACE UNTIL IT IS NO LONGER NEEDED AS DIRECTED BY THE POLLUTION PREVENTION PLAN. GENERALLY SILT FENCES SHALL REMAIN UNTIL THE UPSLOPE AREAS ARE STABILIZED WITH AN ESTABLISHED GRASS COVER AS A MINIMUM.

LOT 1, CORRIDOR INDUSTRIAL PARK

OVERALL SITE

JOHNSON COUNTY IOWA

WHERE PUBLIC UTILITY FIXTURES ARE SHOWN AS EXISTING ON THE PLANS OR ENCOUNTERED WITHIN THE CONSTRUCTION AREA, IT SHALL BE THE RESPONSIBILITY OF THE CONTRACTOR TO NOTIFY THE OWNERS OF THOSE UTILITIES PRIOR TO THE BEGINNING OF ANY CONSTRUCTION. THE CONTRACTOR SHALL AFFORD ACCESS TO THESE FACILITIES FOR NECESSARY MODIFICATION OF SERVICES. UNDERGROUND FACILITIES, STRUCTURES AND UTILITIES HAVE BEEN PLOTTED FROM AVAILABLE SURVEYS AND RECORDS, AND THEREFORE THEIR LOCATIONS MUST BE CONSIDERED APPROXIMATE ONLY. IT IS POSSIBLE THERE MAY BE OTHERS, THE EXISTENCE OF WHICH IS PRESENTLY NOT KNOWN OR SHOWN. IT IS THE CONTRACTOR'S RESPONSIBILITY TO DETERMINE THEIR EXISTENCE AND EXACT LOCATION AND TO AVOID DAMAGE THERETO. NO CLAIMS FOR ADDITIONAL COMPENSATION WILL BE

ALLOWED TO THE CONTRACTOR FOR ANY INTERFERENCE OR DELAY CAUSED BY SUCH WORK.

THE CONTRACTOR SHALL NOTIFY IOWA ONE CALL AT 811 OR 800/292-8989 NO LESS THAN 48 HRS. IN ADVANCE OF ANY DIGGING OR EXCAVATION.

MMS CONSULTANTS, INC Designed by:



C121

C140

C141

C160

C500

L100

STANDARD LEGEND AND NOTES

- - - - - - - - - - - - PROPOSED EASEMENT LINES
----- EXISTING EASEMENT LINES

— — — — — CONGRESSIONAL SECTION LINES

— - CENTER LINES

- BENCHMARK

- PROPERTY &/or BOUNDARY LINES

- LOT LINES, PLATTED OR BY DEED

- PROPOSED BUILDING SETBACK

- EXISTING CENTER LINES - LOT LINES, INTERNAL

- RECORDED DIMENSIONS

CURVE SEGMENT NUMBER

- POWER POLE W/DROP

- POWER POLE W/LIGHT

- SANITARY MANHOLE

FIRE HYDRANT

 WATER VALVE - DRAINAGE MANHOLE

- DECIDUOUS TREE

EVERGREEN TREE

· WATER LINES

- GAS LINES

THE ACTUAL SIZE AND LOCATION OF ALL PROPOSED FACILITIES SHALL BE VERIFIED WITH CONSTRUCTION DOCUMENTS, WHICH ARE TO BE PREPARED AND SUBMITTED SUBSEQUENT TO THE

- ELECTRICAL LINES

- TELEPHONE LINES

- PROPOSED GROUND

- EXISTING TREE LINE

- PROPOSED GEOTHERMAL LINE

- EXISTING SANITARY SEWER

- PROPOSED SANITARY SEWER

- CONTOUR LINES (1' INTERVAL)

- EXISTING STORM SEWER - PROPOSED STORM SEWER

_____X-____X - FENCE LINE


APPROVAL OF THIS DOCUMENT.

- CURB INLET

- POWER POLE W/TRANS

SITE LAYOUT AND DIMENSION PLAN SITE DEMO PLAN OVERALL SITE GRADING AND EROSION CONTROL PLAN

DETAILED SITE GRADING PLAN SITE UTILITY PLAN GENERAL NOTES AND DETAILS SITE LANDSCAPE PLAN

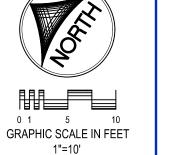

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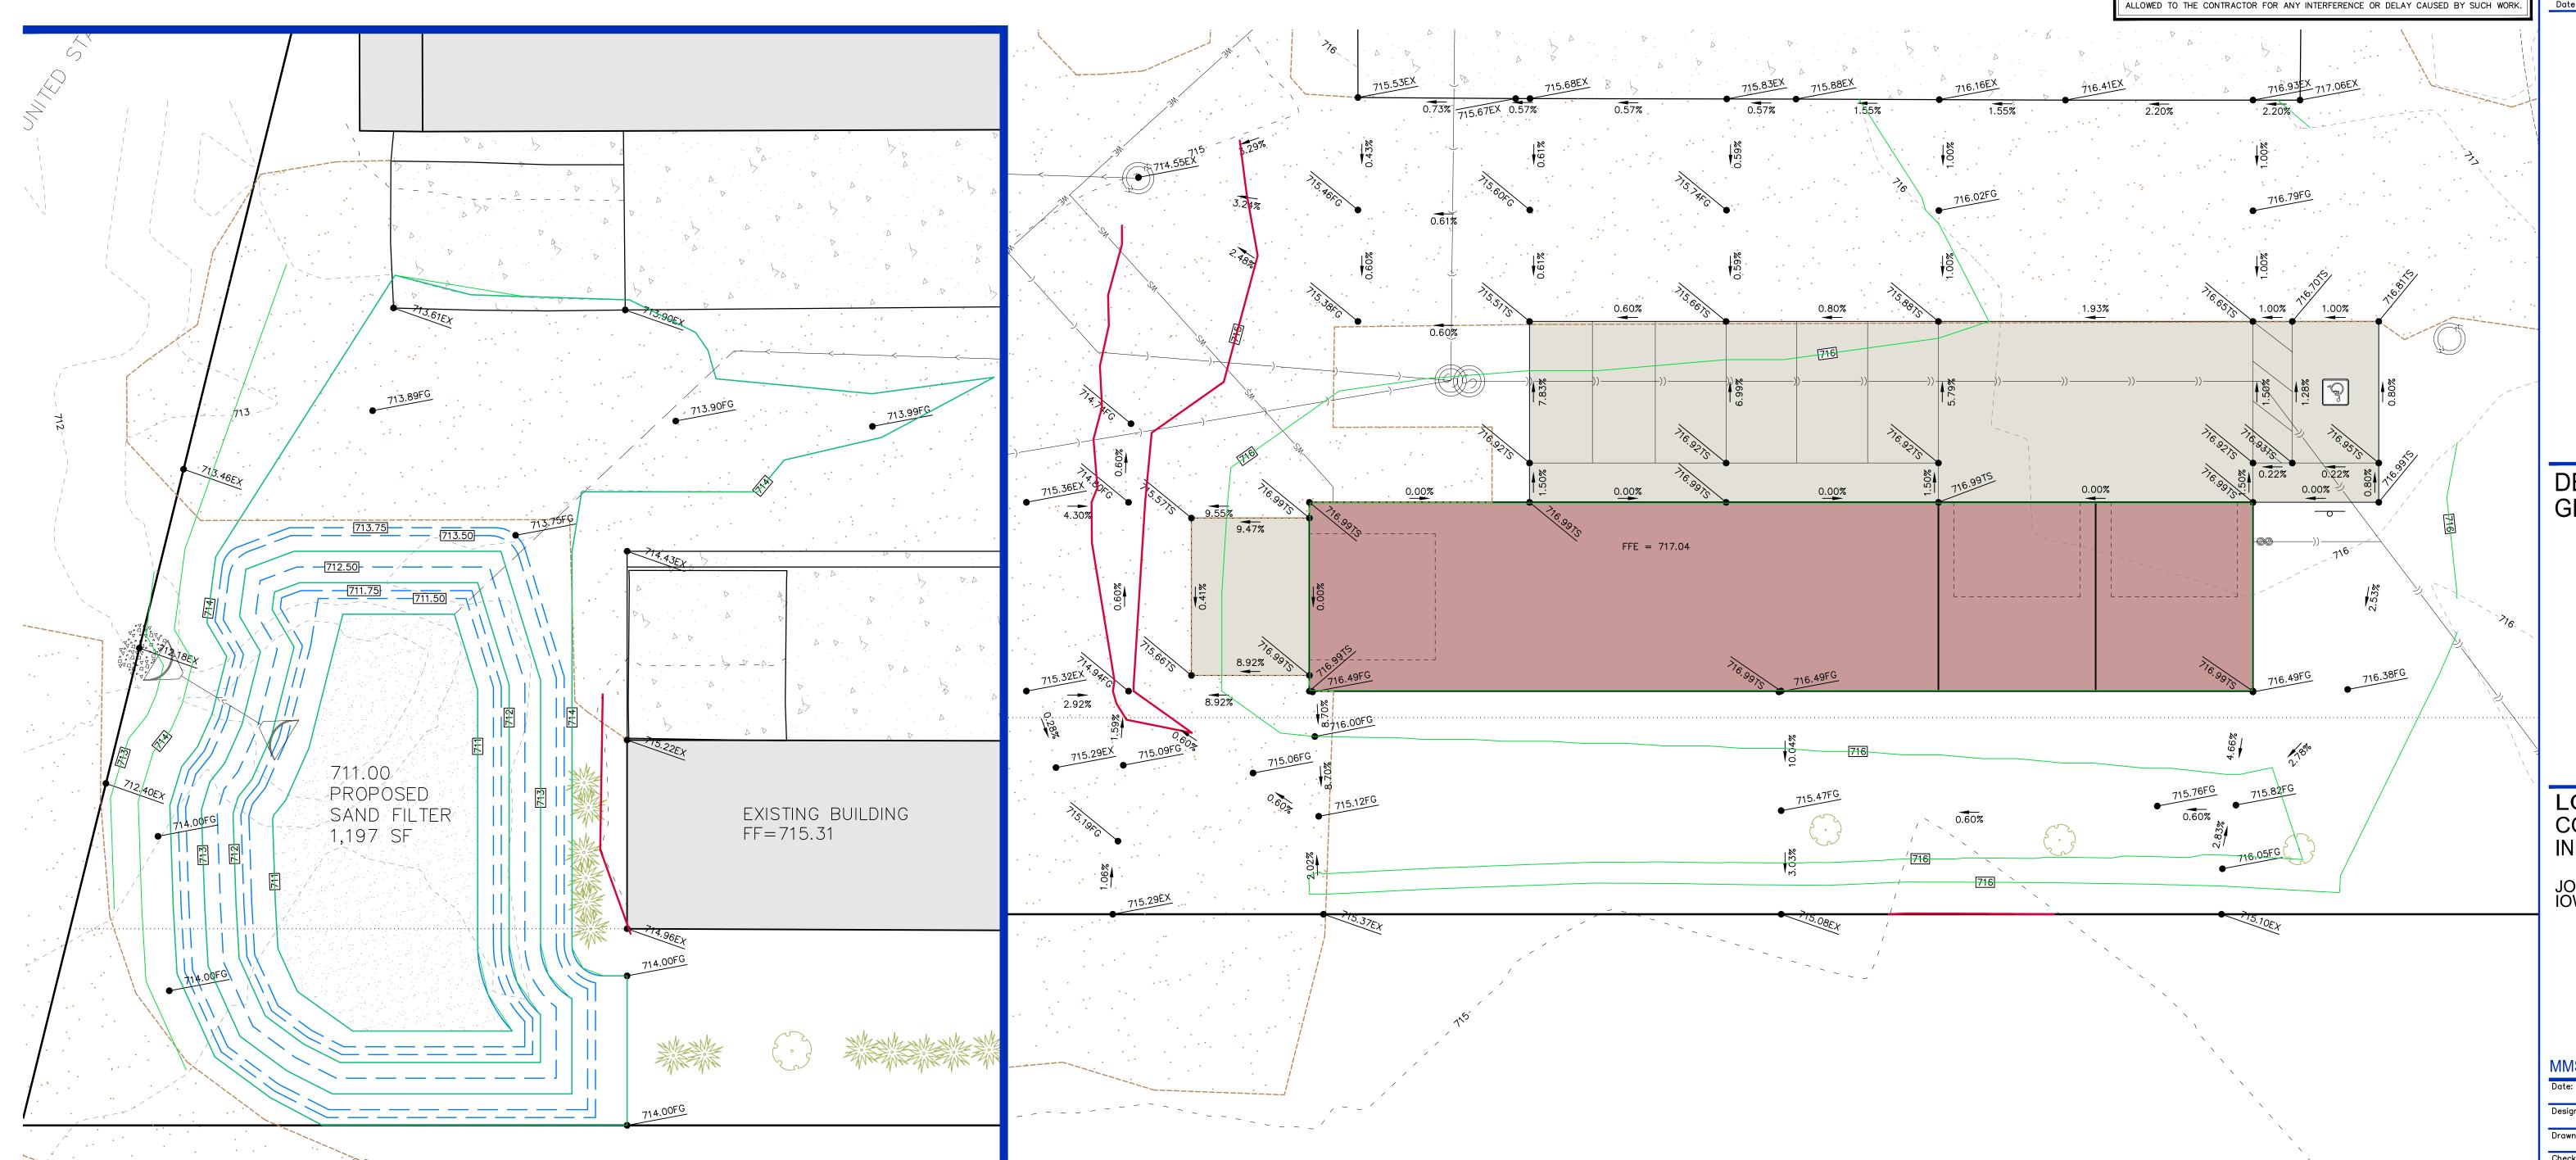
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LAND PLANNERS LAND SURVEYORS LANDSCAPE ARCHITECTS ENVIRONMENTAL SPECIALISTS 1917 S. GILBERT ST. IOWA CITY, IOWA 52240 (319) 351-8282

CIVIL ENGINEERS

www.mmsconsultants.net

1.85 AC



SAND FILTER TYP.

INFILTRATION TO NON-COMPACTED

NATIVE SOIL PROFILE

1. CONTRACTOR SHALL PLACE TOP SOIL WITHOUT COMPACTING. GRADE SHALL BE LEFT 1" HIGH TO ALLOW FOR NATURAL SETTLING.

2. CONTRACTOR SHALL PROVIDE NO LESS THAN 72 HOURS NOTICE TO INSPECTOR PRIOR TO CONSTRUCTION OF STORMWATER

3. SAND FILTER SHALL NOT BE INSTALLED UNTIL AFTER PAVING AND STABILIZATION SEEDING OF THE TRIBUTARY AREA.

4. SURFACE AREA AND BOTTOM OF SAND FILTER SHALL BE GRADED LEVEL END TO END AND SIDE TO SIDE.

CONSTRUCTION NOTES: (REFER TO THE IOWA STORMWATER MANAGEMENT MANUAL CHAPTER 6)

-GRASS TOP

9 INCHES

21 INCHES

3 INCHES TOP SOIL

CPV=CHANNEL PROTECTION VOLUME WQV=WATER QUALITY VOLUME

PERIMETER GRASS FILTER STRIP

FREEBOARD

QUALITY PRACTICES.

WQV ELEV PONDING ZONE TITLE TO THE TOTAL PROPERTY OF THE TOTAL PRO

FILTRATION / RETENTION ZONE

(*WASHED CONCRETE SAND*)

(4:1 SLOPE TO TOP OF SAND FILTER)

CPV ELEV

DETAILED SITE GRADING PLAN

LOT 1, CORRIDOR INDUSTRIAL PARK

JOHNSON COUNTY IOWA

MMS CONSULTANTS, INC.


SITE PLAN LOT 1, CORRIDOR INDUSTRIAL PARK JOHNSON COUNTY, IOWA


1917 S. GILBERT STREET 10 N GEORGE ST IOWA CITY, IOWA 52240 NORTH LIBERTY, IOWA 52317

SITE LAYOUT AND DIMENSION PLAN SITE DEMO PLAN OVERALL SITE GRADING AND EROSION CONTROL PLAN DETAILED SITE GRADING PLAN C160 SITE UTILITY PLAN C500 GENERAL NOTES AND DETAILS

SITE LANDSCAPE PLAN

L100

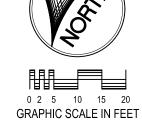

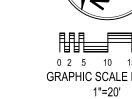

— – EXISTING CENTER LINES

– EXISTING EASEMENT LINES

- RECORDED DIMENSIONS

POWER POLEPOWER POLE W/DROPPOWER POLE W/TRANS

- POWER POLE W/LIGHT

- SANITARY MANHOLE

- DRAINAGE MANHOLE

EVERGREEN TREE

 WATER LINES – ELECTRICAL LINES– TELEPHONE LINES

- PROPOSED GROUND

— – GAS LINES

- PROPOSED GEOTHERMAL LINE - EXISTING SANITARY SEWER - EXISTING STORM SEWER - PROPOSED STORM SEWER

- - - CONTOUR LINES (1' INTERVAL)

GUY POLELIGHT POLE


FIRE HYDRANT

WATER VALVE

- CURB INLET - DECIDUOUS TREE

SHRUBS

CURVE SEGMENT NUMBER

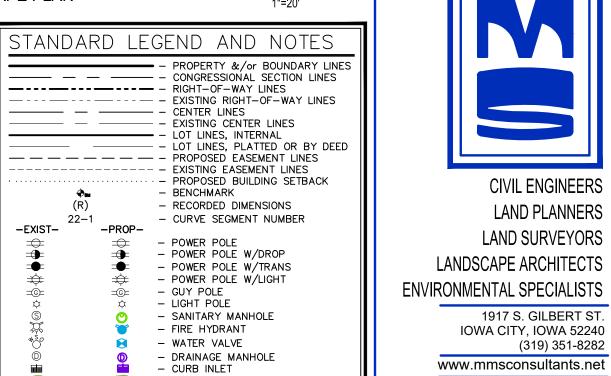

SITE UTILITY PLAN

LOT 1, CORRIDOR INDUSTRIAL PARK


JOHNSON COUNTY IOWA


NO LESS THAN 48 HRS. IN ADVANCE OF ANY DIGGING OR EXCAVATION. WHERE PUBLIC UTILITY FIXTURES ARE SHOWN AS EXISTING ON THE PLANS OR ENCOUNTERED WITHIN THE CONSTRUCTION AREA, IT SHALL BE THE RESPONSIBILITY OF THE CONTRACTOR TO NOTIFY THE OWNERS OF THOSE UTILITIES PRIOR TO THE BEGINNING OF ANY CONSTRUCTION. THE CONTRACTOR SHALL AFFORD ACCESS TO THESE FACILITIES FOR NECESSARY MODIFICATION OF SERVICES. UNDERGROUND FACILITIES, STRUCTURES AND UTILITIES HAVE BEEN PLOTTED FROM AVAILABLE SURVEYS AND RECORDS, AND THEREFORE THEIR LOCATIONS MUST BE CONSIDERED APPROXIMATE. ONLY. IT IS POSSIBLE THERE MAY BE OTHERS, THE EXISTENCE OF WHICH IS PRESENTLY NOT KNOWN OR SHOWN. IT IS THE CONTRACTOR'S RESPONSIBILITY TO DETERMINE THEIR EXISTENCE AND EXACT LOCATION AND TO AVOID DAMAGE THERETO. NO CLAIMS FOR ADDITIONAL COMPENSATION WILL BE


ALLOWED TO THE CONTRACTOR FOR ANY INTERFERENCE OR DELAY CAUSED BY SUCH WORK.

THE CONTRACTOR SHALL NOTIFY IOWA ONE CALL AT 811 OR 800/292-8989


MMS CONSULTANTS, INC. 07/18/2024 Designed by: Drawn by: C160

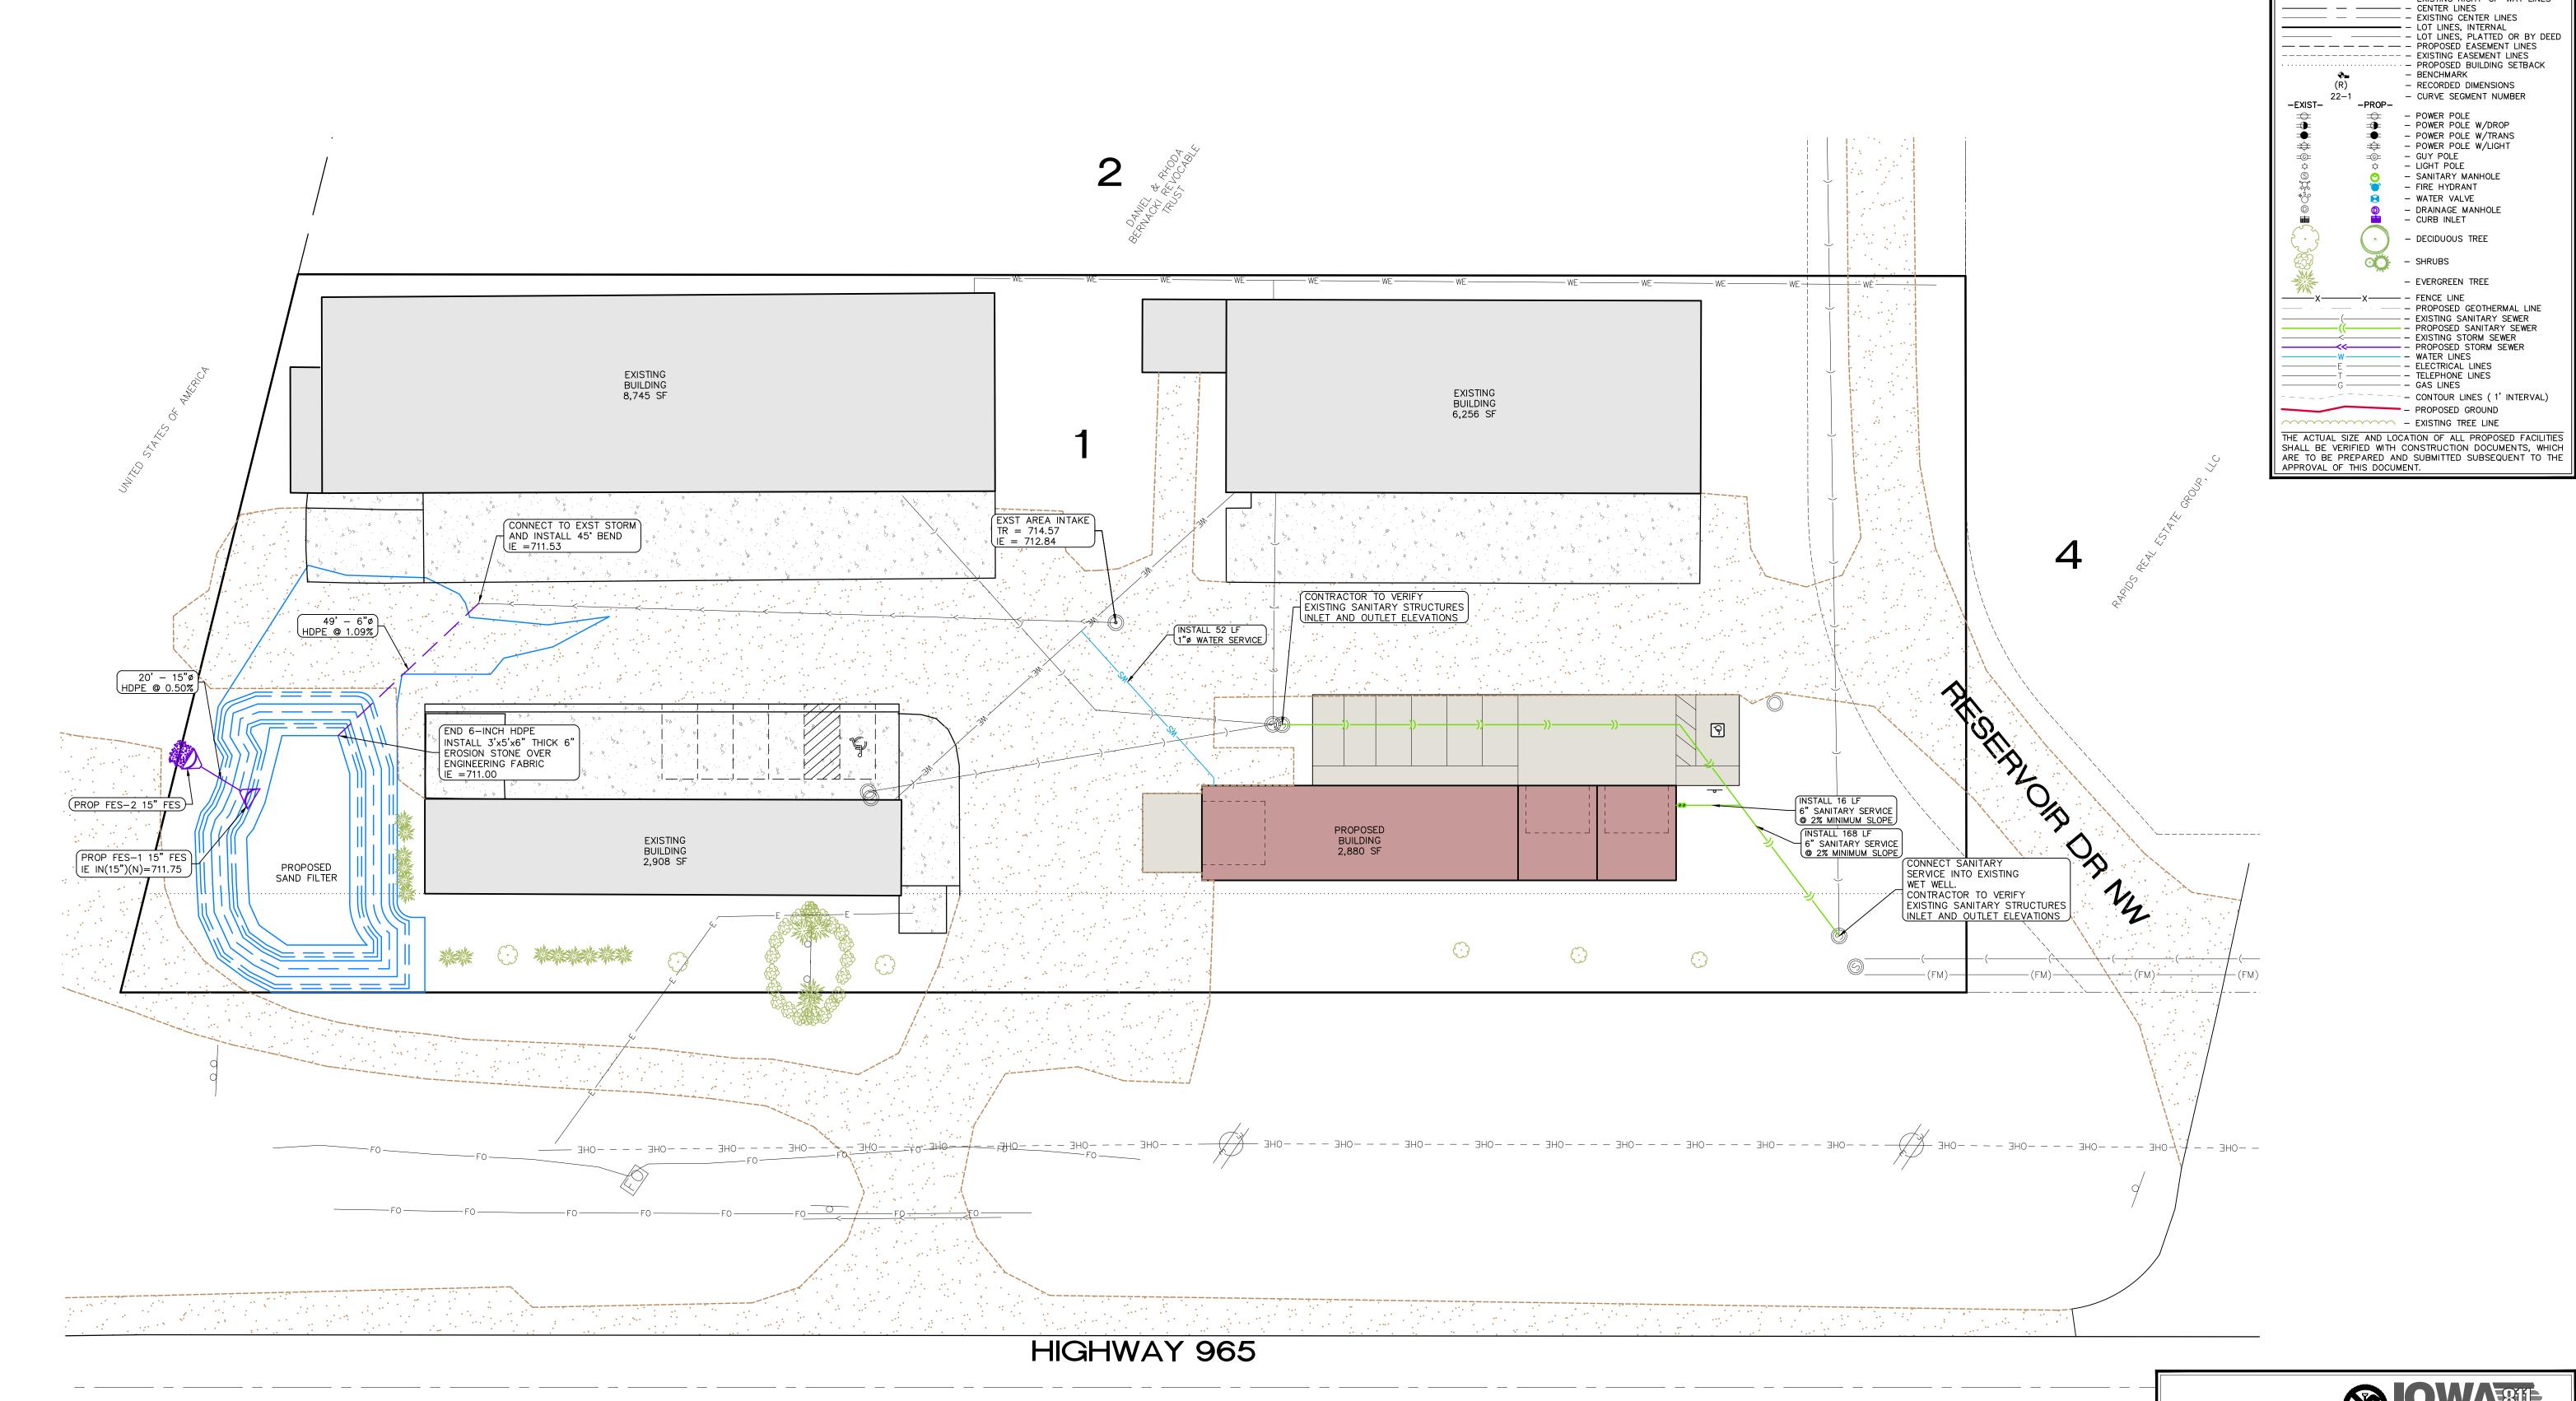

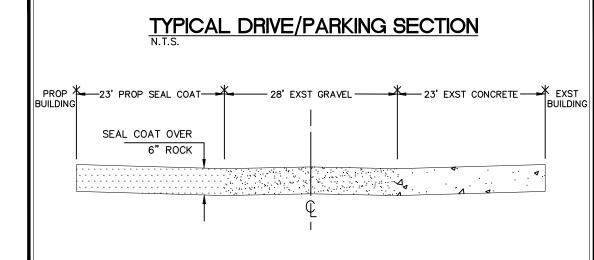

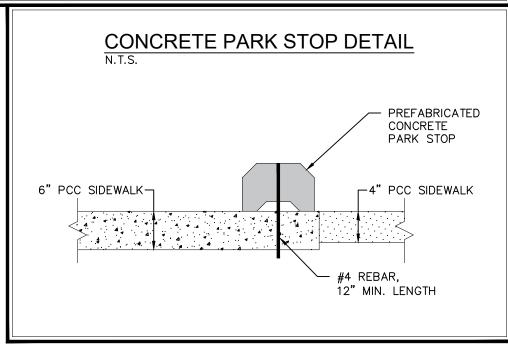

CONCRETE WASHOUT AREA DETAIL

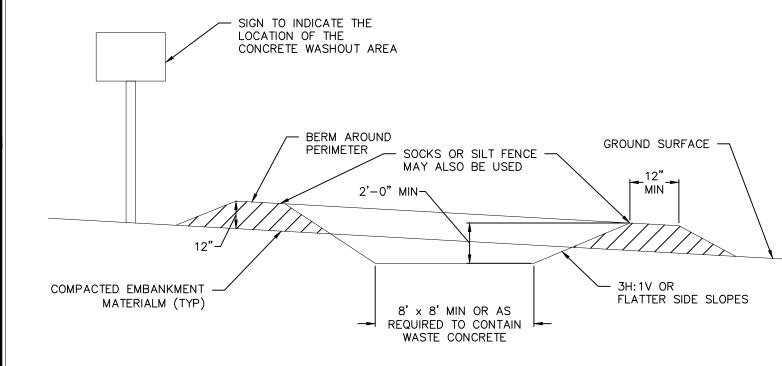



NOTES:
1) CONCRETE WASHOUT AREA SHALL BE INSTALLED PRIOR TO ANY CONCRETE PLACEMENT ON SITE.

- 2) A SIGN SHALL BE PLACED AT THE WASHOUT AREA TO CLEARLY INDICATE THE LOCATION OF THE CONCRETE WASHOUT AREA TO OPERATORS OF CONCRETE TRUCKS AND PUMP RIGS.
- 3) THE CONCRETE WASHOUT AREA SHALL BE REPAIRED AND ENLARGED OR CLEANED OUT AS NECESSARY TO MAINTAIN CAPACITY FOR WASTED CONCRETE.
- 4) AT THE END OF CONSTRUCTION, ALL CONCRETE SHALL BE REMOVED FROM THE SITE AND DISPOSED OF AT AN ACCEPTED WASTE SITE.
- 5) WHEN THE CONCRETE WASHOUT AREA IS REMOVED, THE DISTURBED AREA SHALL BE SEEDED AND MULCHED OR OTHERWISE STABILIZED IN A MANNER ACCEPTED BY THE CITY.
- 6) A SLIT FENCE OR OTHER DEVICE MAY BE USED IN PLACE OF DIRT BERM.

STORM SEWER CONSTRUCTION NOTES

- 1) ALL STORM SEWER AND SUB-SURFACE CONSTRUCTION SHALL CONFORM TO PLANS AND DETAILS PREPARED FOR THIS PROJECT BY MMS CONSULTANTS, INC., AS WELL AS CONFORM TO THE IOWA STATEWIDE URBAN DESIGN AND SPECIFICATIONS (SUDAS) MANUAL. CONSTRUCTION SHALL ALSO CONFORM TO THE CURRENT JOHNSON COUNTY DESIGN STANDARDS, WHICH SHALL SUPERSEDE PLANS AND DETAILS PROVIDED BY MMS CONSULTANTS.
- 2) ALL STORM SEWER INTAKE AND MANHOLE LIDS SHALL HAVE THE WORDS "STORM SEWER" CAST INTO THE LID.
 3) ALL REINFORCED CONCRETE PIPE (RCP) SHALL CONFORM TO SUDAS SPECIFICATION 4020, WITH THE FOLLOWING ADDITIONAL RESTRICTIONS: ALL RCP JOINTS FOR 36" AND SMALLER PIPE SHALL HAVE TONGUE AND GROOVE JOINTS INCORPORATING RUBBER "O"—RING OR PROFILE GASKETS COMPLYING WITH ASTM C443.
- 4) RCP PIPE BEDDING SHALL CONFORM TO SUDAS FIGURE 3010.102 CLASS R-1. CLASS 1 BEDDING MATERIAL SHALL BE AS SPECIFIED IN SUDAS SPECIFICATION 3010,2.02. TRENCH BACKFILL SHALL BE SUITABLE EXCAVATED MATERIAL AS IDENTIFIED IN SUDAS SPECIFICATION 3010,2.01, PLACED AND COMPACTED IN ACCORDANCE WITH SECTIONS 3.05, D AND E. THE OWNER MAY ELECT TO TEST TRENCH COMPACTION AT THEIR OWN EXPENSE.
- 5) SUB-SURFACE DRAINAGE PIPE SHALL BE HIGH DENSITY POLYETHYLENE PIPE (HDPE) CONFORMING TO SUDAS SPECIFICATION 4040 FOR BOTH PERFORATED TILE AND SOLID WALL PIPE.
- 6) FOR SUB-SURFACE DRAINAGE IN TURF AREAS HDPE PIPE BEDDING SHALL CONFORM TO SUDAS FIGURE 3010.103 CLASS F-3.
 BEDDING MATERIAL SHALL BE POROUS BACKFILL MATERIAL AS SPECIFIED IN SUDAS SPECIFICATION 4040,2.04. TRENCH BACKFILL SHALL BE SUITABLE EXCAVATED MATERIAL AS IDENTIFIED IN SUDAS SPECIFICATION 3010,2.01 PLACED AND COMPACTED IN ACCORDANCE WITH SECTIONS 3.05 D AND E.
- 7) AT LOCATIONS WHERE A FLARED END SECTION IS REQUIRED, THE PIPE LENGTHS SHALL BE MEASURED TO THE END OF THE FLARED END. THE FLARED END SECTION AND THE TWO UPSTREAM JOINTS ARE TO INCORPORATE TIED JOINTS.
- 8) ALL FIELD TILE ENCOUNTERED DURING CONSTRUCTION SHALL BE CONNECTED TO THE PROPOSED STORM SEWER. NOTIFY ENGINEER OF ALL FIELD TILES ENCOUNTERED.
- 9) CONTRACTOR SHALL PROVIDE A FIVE—YEAR MAINTENANCE BOND COVERING DEFECTIVE MATERIALS AND WORKMANSHIP FOR ALL STORM SEWER SYSTEM IMPROVEMENTS.

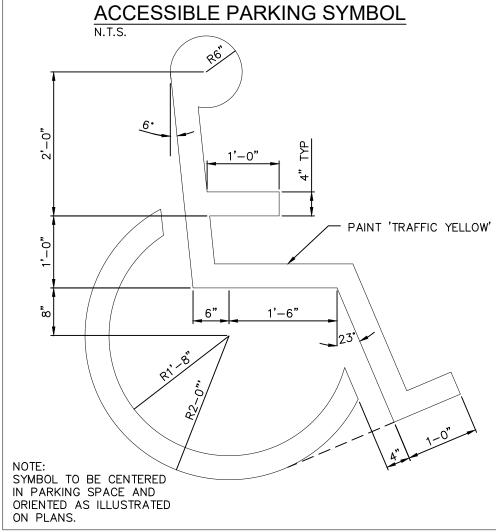

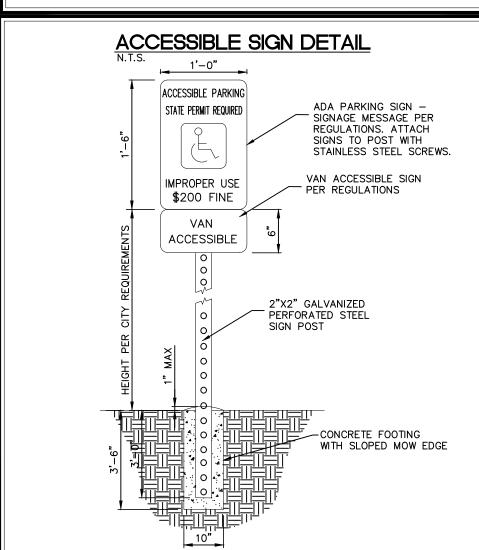

GENERAL NOTES AND DETAILS

1.85 AC

CIVIL ENGINEERS

LAND PLANNERS

LAND SURVEYORS

1917 S. GILBERT ST.

(319) 351-8282

IOWA CITY, IOWA 52240

www.mmsconsultants.net

LANDSCAPE ARCHITECTS

ENVIRONMENTAL SPECIALISTS

Date Revision

LOT 1, CORRIDOR INDUSTRIAL PARK

JOHNSON COUNTY IOWA

MMS CONSULTANTS, INC.

Designed by:
BJC

Drawn by:
ADP
Checked by:
BJC

Project No:

O7/18/2024

Field Book No:
Scale:
N.T.S.

Sheet No:

Project No:

11987-001

HIGHWAY 965



(319) 351-8282

1.85 AC

SITE LANDSCAPE PLAN

LOT 1, CORRIDOR INDUSTRIAL PARK

JOHNSON COUNTY IOWA

MMS CONSULTANTS, INC. 07/18/2024 Designed by: Drawn by:

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